

LOCATION MAP


40 YEAR BUILDING REPAIR AND RESTORATION

PHASE IIC: OVERALL BUILDING REPAIR AND RESTORATION

CHAMPLAIN TOWERS SOUTH CONDOMINIUM

8777 COLLINS AVENUE
SURFSIDE, FLORIDA 33154

100% BID DOCUMENTS SET - 4/26/21

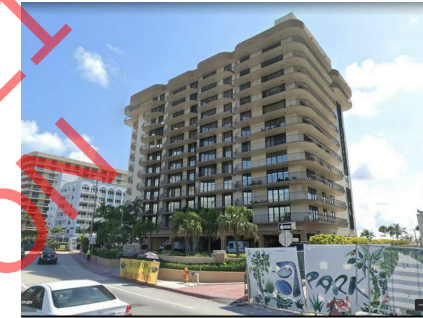

STREET VIEW

CHAMPLAIN TOWERS
SOUTH CONDOMINIUM
8777 COLLINS AVENUE
SURFSIDE, FLORIDA 33154

CHAMPLAIN TOWERS SOUTH 40-YEAR BUILDING
REPAIR & RESTORATION
PHASE IIC: OVERALL BUILDING
REPAIR AND RESTORATION

DRAWING LIST - PHASE IIC STRUCTURAL

DRAWING LIST - PHASE IIC ARCHITECTURAL

DRAWING LIST - PHASE IIC LANDSCAPE

- .C2C-1.0 COVERSHEET
- .C2C-1.1 GENERAL NOTES & DESIGN DATA
- A2C-0.5 BASEMENT PARKING PLAN
- A2C-1.0 LEVEL 1 FLOOR PLAN
- A2C-1.1 LEVEL 2-8 FLOOR PLAN
- A2C-1.2 LEVEL 9-11 FLOOR PLAN
- A2C-1.3 LEVEL 12 FLOOR PLAN
- A2C-1.4 LOW ROOF & PENTHOUSE FLOOR PLAN
- A2C-1.5 PENTHOUSE AND HIGH ROOF PLAN
- D2C-1.0 LEVEL 1 DEMO PLAN
- S2C-1.0 LEVEL 1 SLAB REINFORCEMENT AND FRAMING PLAN
- S2C-1.1 LEVEL 1 BONDED OVERLAY AND TOPPING ELEVATIONS
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- S2C-2.0 TYPICAL REINFORCEMENT & REPAIR NOTES
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- S2C-2.3 PLAZA DETAILS
- S2C-2.4 PLAZA DETAILS
- S2C-2.5 PLAZA DETAILS
- S2C-2.6 PLAZA DETAILS
- S2C-2.7 PLAZA DETAILS
- S2C-2.8 PLAZA DETAILS
- S2C-2.9 PLAZA & FOUNDATION DETAILS
- S2C-3.0 POOL REPAIR DETAILS
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- S2C-3.2 SOFFIT AND RAIL REPAIR DETAILS
- S2C-3.3 BALCONY DOOR WATERPROOFING
- S2C-3.4 SHORING DETAILS
- S2C-3.5 FIRE DOOR REPLACEMENT DETAILS
- S2C-3.6 SOUTH WALL REPAIR
- TBM-1 TRAFFIC BEARING WATERPROOFING MEMBRANE & FINISH
- WP-1 CCW-500 WALL DETAILS
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- WP-5 CCW-500 DRAINS
- WP-6 CCW-500 PAVERS
- WP-7 CCW-500 PENETRATIONS
- WP-8 MIRACOTE POOL MEMBRANE

- A-1 OVERALL FIRST FLOOR RAMP, WINDOW & DOOR PLAN
- A-2 OVERALL 2ND THRU 8TH FLOOR WINDOW & DOOR PLAN
- A-3 OVERALL 8TH THRU 11TH FLOOR WINDOW & DOOR PLAN
- A-4 OVERALL 12TH FLOOR WINDOW & DOOR PLAN
- A-5 OVERALL ROOF & PENTHOUSE FLOOR WINDOW & DOOR PLAN
- A-6 DOOR & WINDOW ELEVATION PROFILES
- A-7 DOOR & WINDOW SCHEDULE, DOOR & WINDOW NOTES, DOOR HARDWARE SCHEDULE
- A-8 WEST & NORTH BUILDING ELEVATIONS
- A-9 EAST 7 SOUTH BUILDING ELEVATIONS
- A-10 PRELIMINARY COLOR CHART & NEW BUILDING ELEVATIONS

- LD-1 TREE DISPOSITION PLAN
- LH-1 HARDSCAPE PLAN
- LP-1 LANDSCAPE PLAN
- LR-1 IRRIGATION PLAN AND LEGEND
- LR-2 IRRIGATION NOTES AND DETAILS
- LT-1 LANDSCAPE LIGHTING PLAN

DRAWING LIST - PHASE IIC MEP

- E-0 ELECTRICAL SYMBOL LEGEND AND NOTES
- E-1 BASEMENT PARKING PLAN - LIGHTING
- E-2 FIRST FLOOR PARKING PLAN - LIGHTING
- E-3 BASEMENT PARKING PLAN - POWER
- E-4 PENTHOUSE FLOOR PLAN / LOWER ROOF
- E-5 GENERATOR ROOM PLAN
- E-6 ELECTRICAL NOTES
- E-7 ELECTRICAL GEAR SPECIFICATIONS
- E-8 ELECTRICAL PANELS
- E-9 ELECTRICAL DETAILS
- FP-1 FIRE PROTECTION NOTES, SCHEDULES AND DETAILS
- FP-2 FIRST FLOOR PLAN - FIRE PROTECTION
- M-0 MECHANICAL NOTES AND SCHEDULES
- M-1 MECHANICAL - HVAC GARAGE PLAN
- M-2 MECHANICAL GROUND FLOOR PLAN
- M-3 LOW ROOF HVAC REPLACEMENT PLAN
- P-0 PLUMBING GENERAL NOTES AND DETAILS
- P-0A NATURAL GAS BASEMENT PARKING PLAN
- P-1 PLUMBING GAS GARAGE PLAN
- P-1A NATURAL GAS BASEMENT PLAN
- P-2 PLUMBING - FIRST FLOOR PARKING PLAN
- P-2A NATURAL GAS - FIRST FLOOR PARKING PLAN

SPECIFICATIONS

- SECTION 00 2113 INSTRUCTION TO BIDDERS
- SECTION 00 4100 BID FORM
- SECTION 00 5213 CONTRACT AGREEMENT FORM
- SECTION 00 7212 ADDITIONS TO THE CONTRACT AGREEMENT
- SECTION 00 7300 SUPPLEMENTAL CONTRACT CONDITIONS
- SECTION 01 1100 SUMMARY OF WORK
- SECTION 01 2100 ALLOWANCES
- SECTION 01 2200 UNIT PRICES
- SECTION 01 2300 ALTERNATES
- SECTION 01 3100 PROJECT MANAGEMENT AND COORDINATION
- SECTION 01 3300 SUBMITTAL PROCEDURES
- SECTION 01 4000 QUALITY REQUIREMENTS
- SECTION 01 5000 TEMPORARY FACILITIES & CONTROL
- SECTION 01 6000 PRODUCT REQUIREMENTS
- SECTION 01 7300 EXECUTION
- SECTION 01 7400 CLEANING & WASTE MANAGEMENT
- SECTION 02 4119 SELECTIVE DEMOLITION
- SECTION 03 0100 MAINTENANCE OF CONCRETE
- SECTION 04 0120 MAINTENANCE OF MASONRY
- SECTION 04 1100 PREPARATION OF LIME OR PORTLAND BASED STUCCO
- SECTION 04 1101 REPAIR OF STUCCO
- SECTION 05 0519 POST-INSTALLED ANCHORS IN CONCRETE & MASONRY
- SECTION 05 4000 COLD FORMED METAL FRAMING
- SECTION 05 5000 METAL FABRICATIONS
- SECTION 07 1413 HOT FLUID APPLIED RUBBERIZED ASPHALT WATERPROOFING
- SECTION 07 1610 CEMENTITIOUS AND REACTIVE WATERPROOFING
- SECTION 07 1810 PEDESTRIAN BEARING WATERPROOFING MEMBRANE
- SECTION 07 9200 SEALANT
- SECTION 09 2400 PORTLAND CEMENT PLASTERING STUCCO
- SECTION 09 9120 PAINTING
- SECTION 31 4100 SHORING
- SECTION 32 1400 CLAY AND CONCRETE UNIT PAVING
- SECTION 32 9218 TOPSOIL FINISH GRADING SHRUBS & SOD

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Expiry 02/2021

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No.	Date	Revisions

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Project No.: 18217		Date: 04/26/21	
Scale: As indicated		Sheet Title: COVERSHEET	

Sheet No.:
C2C-1.0

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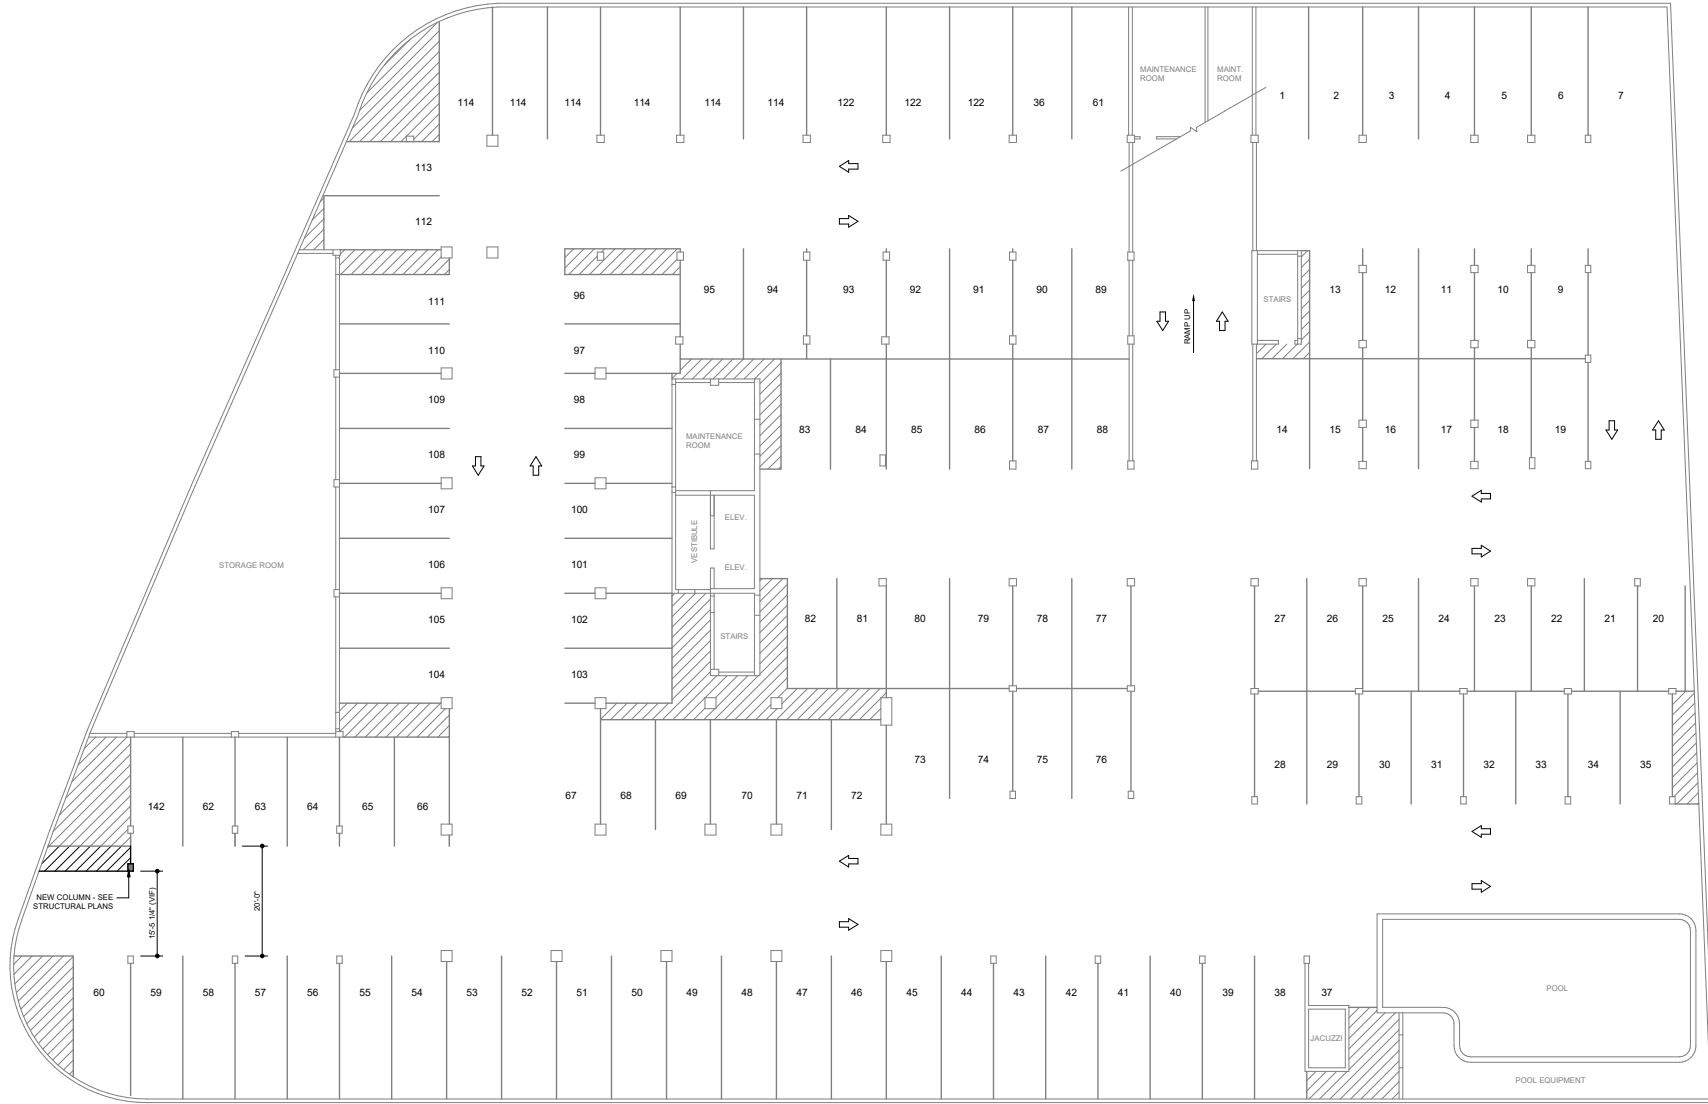
Date: 04/26/21

Scale: 3/32" = 1'-0"

Sheet Title:
BASEMENT PARKING
PLAN

Sheet No.:

A2C-0.5



PLAN NOTES

- EXISTING BUILDING FRAMING AND CONDITIONS INDICATED ON PLAN ARE BASED ON EXISTING DRAWINGS PREPARED BY WILLIAM M. FRIEDMAN & ASSOCIATES ARCHITECTS, INC. AND BREITERMAN JUARDO & ASSOCIATES, DATED 08-22-1979 AND A LIMITED FIELD INVESTIGATION CONDUCTED BY MORABITO CONSULTANTS. CONTRACTOR SHALL VERIFY ALL EXISTING CONDITIONS AND CONTACT MORABITO CONSULTANTS PRIOR TO CONSTRUCTION IF CONDITIONS VARY FROM WHAT IS SHOWN ON PLAN.
- EXISTING STRUCTURE CONSISTS OF CAST-IN-PLACE CONCRETE TWO-WAY FLAT PLATE ELEVATED FLOOR SLABS BEARING ON CAST-IN-PLACE CONCRETE COLUMNS OVER A FRAMED CONCRETE SLAB ON GRADE SUPPORTED BY PILE CAPS.
- EXISTING ELEVATION TOP OF STRUCTURAL SLAB VARIES.
- EXISTING CONDITIONS ARE SHOWN HALF-TONE.
- ALL STRIPING SHALL BE 4" IN WIDTH.
- ALL NON-PARKING AREAS SHALL HAVE 4" WIDE PAINTED STRIPING AT 1'-6" ON.
- ALL STRIPING FOR THE STANDARD STALLS AND ASSOCIATED NON-PARKING AREAS SHOULD BE YELLOW.
- ALL STRIPING FOR THE HANDICAP STALLS AND ASSOCIATED NON-PARKING AREAS SHOULD BE SKY BLUE. THE HANDICAP FIGURE SHOULD BE WHITE WITH A SKY-BLUE BACKGROUND.
- PARKING SPACE NUMBERING IN 6" LETTERING TO END OF PARKING SPACE AND ON COLUMN ADJACENT TO SPACE PER PAINT SPECIFICATION SECTION 09 9120. PARKING SPACE NUMBERING AS NOTED ON THIS SHEET.
- APPLY SILANE SEALER TO ALL CONCRETE SLAB ON GRADE AREAS. SEE SPECIFICATION 03 0100.

EXISTING STANDARD PARKING THIS LEVEL = 120 SPACES
EXISTING PARKING THIS LEVEL = 120 SPACES

CHAMPLAIN TOWERS SOUTH CONDOMINIUM
8777 COLLINS AVENUE
SURFSIDE, FLORIDA 33154

**CHAMPLAIN TOWERS SOUTH 40-YEAR BUILDING
REPAIR & RESTORATION
PHASE IIC: OVERALL BUILDING
REPAIR AND RESTORATION**

SEAL License 9800
Expire 02/2023



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Sheet Title:			
LEVEL 1 FLOOR PLAN			
Sheet No.:			
A2C-1.0			



- PLAN NOTES**
- TYPICAL VEHICULAR PAVEMENT SYSTEM SHALL BE 2-3/8" CONCRETE INTERLOCKING PAVERS OVER 1" SETTING BED CONSISTING OF A BLEND OF 3 PARTS ASTM C33 SAND AND 1 PART DRY TYPE IV LOW HEAT HYDRATION PORTLAND CEMENT. SEE LANDSCAPE ARCHITECT PLANS FOR PAVEMENT STYLES AND PATTERNS. TYPICAL PAVEMENT JOINTS SHALL HAVE POLYMER AGGREGATE. SEE SPECIFICATION SECTION 32 14 00 FOR ADDITIONAL REQUIREMENTS. PAVER SYSTEM TO BE PLACED OVER SLOPED CONCRETE TOPPING PER STRUCTURAL PLANS.
 - VEHICULAR PAVEMENT AREAS AT TRANSITIONS TO SIDEWALK / ROADWAY SHALL BE MORTAR SET ON DRAINAGE BOARD FOR MINIMUM 2'-0" WIDTH. UNO. MORTAR SET PAVERS SHALL HAVE GROUDED JOINTS. SEE SPECIFICATION SECTION 32 14 00 FOR MORTAR AND GROUT REQUIREMENTS. SEE SHEET WP-6 FOR MORTAR SET DETAILS.
 - TYPICAL NON-VEHICULAR PAVEMENT SYSTEM SHALL BE 2-3/8" CONCRETE INTERLOCKING PAVERS OVER 1" SETTING BED CONSISTING OF ASTM C33 SAND. SEE LANDSCAPE ARCHITECT PLANS FOR PAVEMENT STYLES AND PATTERNS. TYPICAL PAVEMENT JOINTS SHALL HAVE POLYMER AGGREGATE. SEE SPECIFICATION SECTION 32 14 00 FOR ADDITIONAL REQUIREMENTS. PAVER SYSTEM TO BE PLACED OVER SLOPED CONCRETE TOPPING PER STRUCTURAL PLANS.
 - ALL STEP RISERS AND TREAD PAVERS SHALL BE MORTAR SET ON DRAINAGE BOARD AND JOINT GROUDED. SEE SPECIFICATION SECTION 32 14 00 FOR MORTAR AND GROUT REQUIREMENTS. SEE SHEET WP-6 FOR MORTAR SET DETAILS.
 - REPLACE GLASS WINDOWS AND DOORS AT FIRST FLOOR COMMON AREAS AS NOTED ON PLAN. REPLACEMENT WINDOWS AND DOORS SHALL HAVE AN APPROVED NGA MEETING THE REQUIREMENTS OF THE 2020 IRC. REPLACEMENT INCLUDES NEW WOOD BUICKS, WATERPROOFING OF MASONRY OPENING AND WOOD BUICKS, AND PLACEMENT OF TEMPORARY WEATHER WALLS TO PROTECT THE INTERIOR DURING DOOR REPLACEMENT STRUCTURAL REINFORCEMENTS.
 - NEW PLANTER WALLS ARE INDICATED ON PLAN THIS [Hatched Pattern] AND BE TOOTHED INTO EXISTING CMU TO REINFORCE.
 - NEW SOIL AND PLANTING MATERIAL SHALL BE LIGHTWEIGHT (80 PCF MAX) AND SHALL NOT EXCEED 1'-0" DEEP, EXCEPT AT TREE LOCATIONS. CONTRACTOR SHALL PROVIDE GEOFOAM INFILL AS REQUIRED TO ACHIEVE TOP OF SOIL ELEVATIONS IN PLANTERS. SUBMIT SOIL DATA FOR APPROVAL. NEW PLANTER SOIL INDICATED AS THIS [Pattern].
 - NEW AND REPLACEMENT PLANTER AND HARDSCAPE DRAIN LOCATIONS ARE SHOWN ON THE PLAN. SEE S2C-1.1 FOR CONCRETE TOPPING SLOPES. SEE PLUMBING FOR DRAIN TYPES.
 - RESTORE PARKING SPACES WITH THE QUANTITY OF SPACES AS SHOWN. ALL PARKING STRIPING SHALL BE YELLOW AND 4" IN WIDTH. SEE PROJECT SPECIFICATIONS FOR PAINTING REQUIREMENTS.
 - CONTRACTOR'S MISC METALS FABRICATOR SHALL RETAIN A LICENSED PROFESSIONAL ENGINEER TO DESIGN NEW RAILINGS TO MEET LOAD AND DIMENSIONAL REQUIREMENTS OF THE 2020 FBC. SUBMIT SIGNED AND SEALED SHOP DRAWINGS FOR APPROVAL.
 - SEE BID FORM FOR ALL OTHER ITEMS NOTE SHOWN ON PLAN.
 - APPLY SLANE SEALER TO ALL CONCRETE SLAB ON GRADE AREAS. SEE SPECIFICATION 03 0150.
 - EXISTING POOL FINISH TO BE REMOVED. STRUCTURE REPAIRED AS NECESSARY, AND WATERPROOFING APPLIED. REFERENCE SHEETS S2C-3.0 AND WP-8.
 - CREATE SOLID REINFORCED CONCRETE WALL FOR 5 FOOT WIDTH CENTERED IN FRONT OF PROPOSED GAS METER. SEE DETAIL 750C-1-B.
 - CREATE PARTITIONS FOR EXPANDED ELECTRICAL ROOM. USE 8" ASTM C-96 BLOKS. EPOXY DOWEL & VERTICAL BARS AT ENDS AND WALL MID SPAN AND FILL WITH TYPE S MORTAR. USE HORIZONTAL JOINT REINFORCING EVERY OTHER COURSE. JOINTS TO BE TUCK POINTED. PAINT TO MATCH EXISTING.

CHAMPLAIN TOWERS SOUTH 40-YEAR BUILDING
REPAIR & RESTORATION
PHASE 1C: OVERALL BUILDING
REPAIR AND RESTORATION

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Expires 03/2023

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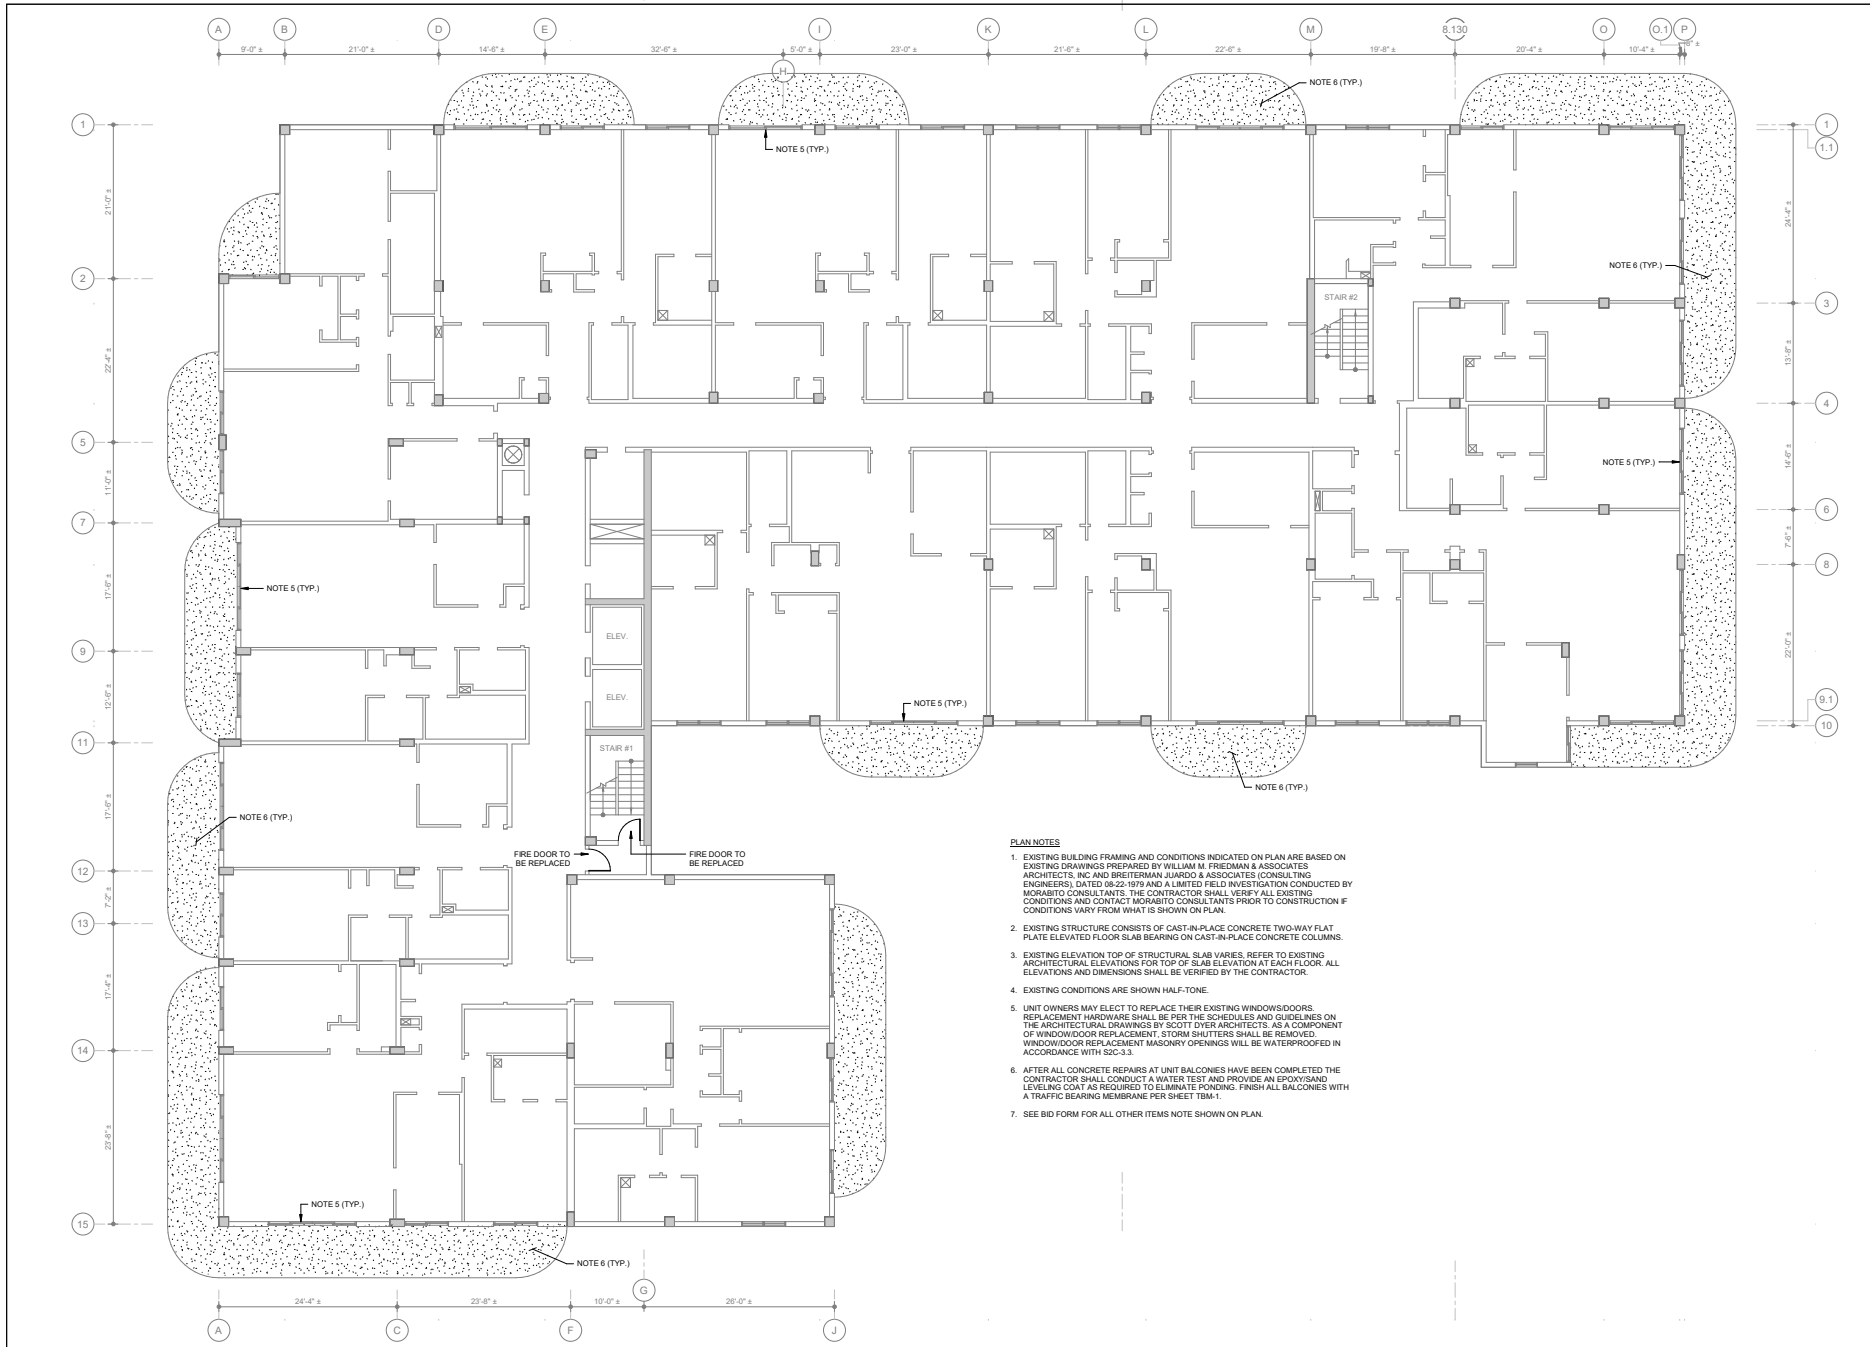
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Structural Engineers | Remediation & Parking Consultants
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No.	Date	Revisions

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CHECKED RM	APPROVED FPM

Project No.: 18217
Date: 04/26/21
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Sheet Title:
LEVEL 2-8 FLOOR PLAN

Sheet No.:
A2C-1.1



- PLAN NOTES**
- EXISTING BUILDING FRAMING AND CONDITIONS INDICATED ON PLAN ARE BASED ON EXISTING DRAWINGS PREPARED BY WILLIAM M. FREEMAN & ASSOCIATES ARCHITECTS, INC. AND BREITERMAN JUARDO & ASSOCIATES (CONSULTING ENGINEERS) DATED 08/22/1979 AND A LIMITED FIELD INVESTIGATION CONDUCTED BY MORABITO CONSULTANTS. THE CONTRACTOR SHALL VERIFY ALL EXISTING CONDITIONS AND CONTACT MORABITO CONSULTANTS PRIOR TO CONSTRUCTION IF CONDITIONS VARY FROM WHAT IS SHOWN ON PLAN.
 - EXISTING STRUCTURE CONSISTS OF CAST-IN-PLACE CONCRETE TWO-WAY FLAT PLATE ELEVATED FLOOR SLAB BEARING ON CAST-IN-PLACE CONCRETE COLUMNS.
 - EXISTING ELEVATION TOP OF STRUCTURAL SLAB VARIES. REFER TO EXISTING ARCHITECTURAL ELEVATIONS FOR TOP OF SLAB ELEVATION AT EACH FLOOR. ALL ELEVATIONS AND DIMENSIONS SHALL BE VERIFIED BY THE CONTRACTOR.
 - EXISTING CONDITIONS ARE SHOWN HALF-TONE.
 - UNIT OWNERS MAY ELECT TO REPLACE THEIR EXISTING WINDOWS/DOORS. REPLACEMENT HARDWARE SHALL BE PER THE SCHEDULES AND GUIDELINES ON THE ARCHITECTURAL DRAWINGS BY SCOTT DYER ARCHITECTS. AS A COMPONENT OF WINDOW/DOOR REPLACEMENT, STORM SHUTTERS SHALL BE REMOVED. WINDOW/DOOR REPLACEMENT MASONRY OPENINGS WILL BE WATERPROOFED IN ACCORDANCE WITH S2C-3.3.
 - AFTER ALL CONCRETE REPAIRS AT UNIT BALCONIES HAVE BEEN COMPLETED THE CONTRACTOR SHALL CONDUCT A WATER TEST AND PROVIDE AN EPoxy/SMR LEVELING COAT AS REQUIRED TO ELIMINATE PONDING. FINISH ALL BALCONIES WITH A TRAFFIC BEARING MEMBRANE PER SHEET TBM-1.
 - SEE BID FORM FOR ALL OTHER ITEMS NOTE SHOWN ON PLAN.

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Expires 02/28/21

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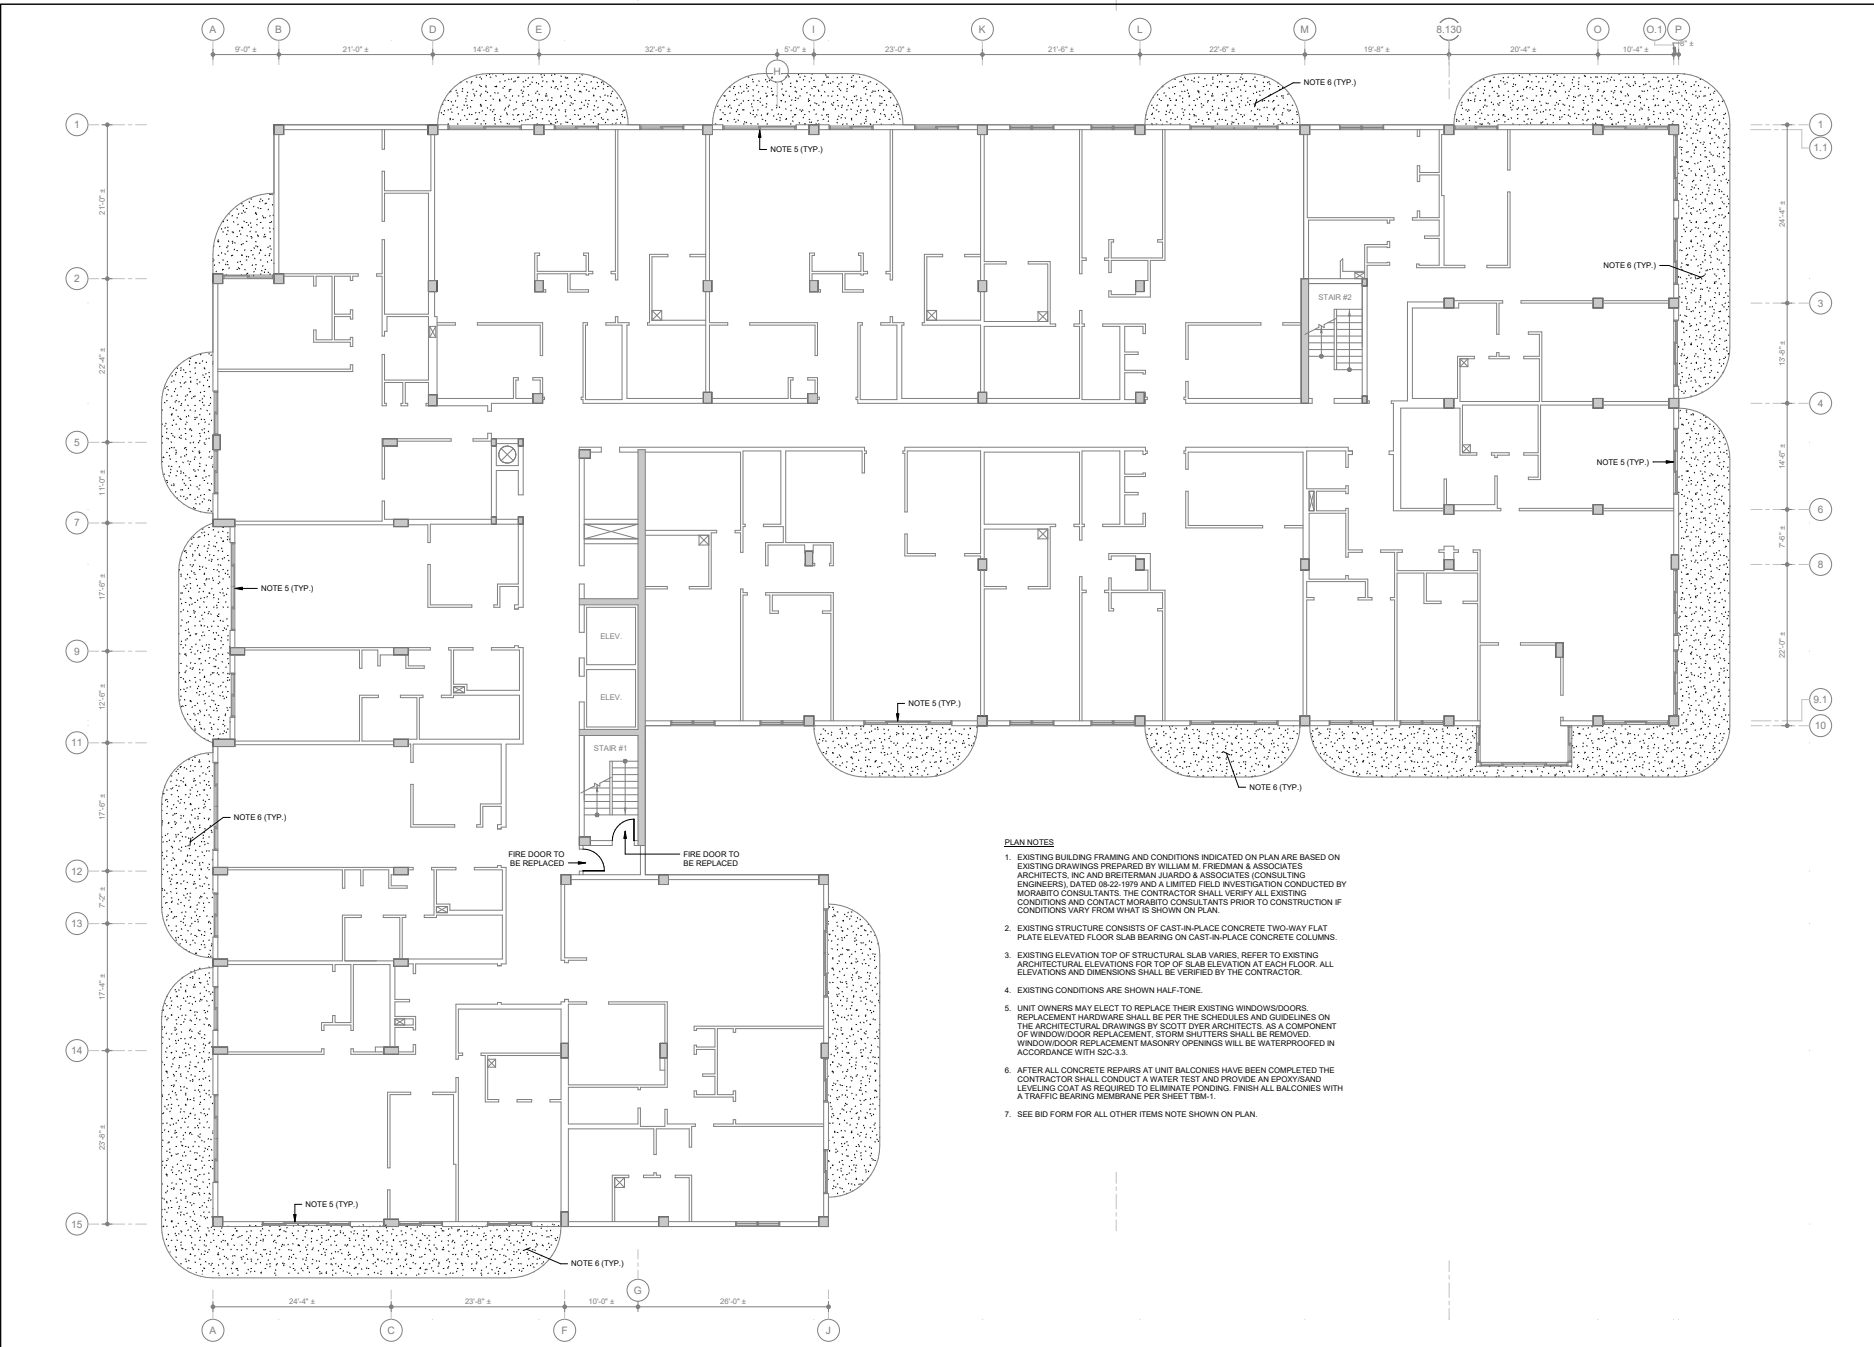
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LEVEL 9-11 FLOOR PLAN

Sheet No.:
A2C-1.2




- PLAN NOTES**
- EXISTING BUILDING FRAMING AND CONDITIONS INDICATED ON PLAN ARE BASED ON EXISTING DRAWINGS PREPARED BY WILLIAM M. FREEMAN & ASSOCIATES ARCHITECTS, INC. AND BREITERMAN JUARDO & ASSOCIATES (CONSULTING ENGINEERS), DATED 08/22/1999, AND A LIMITED FIELD INVESTIGATION CONDUCTED BY MORABITO CONSULTANTS. THE CONTRACTOR SHALL VERIFY ALL EXISTING CONDITIONS AND CONTACT MORABITO CONSULTANTS PRIOR TO CONSTRUCTION IF CONDITIONS VARY FROM WHAT IS SHOWN ON PLAN.
 - EXISTING STRUCTURE CONSISTS OF CAST-IN-PLACE CONCRETE TWO-WAY FLAT PLATE ELEVATED FLOOR SLAB BEARING ON CAST-IN-PLACE CONCRETE COLUMNS.
 - EXISTING ELEVATION TOP OF STRUCTURAL SLAB VARIES. REFER TO EXISTING ARCHITECTURAL ELEVATIONS FOR TOP OF SLAB ELEVATION AT EACH FLOOR. ALL ELEVATIONS AND DIMENSIONS SHALL BE VERIFIED BY THE CONTRACTOR.
 - EXISTING CONDITIONS ARE SHOWN HALF-TONE.
 - UNIT OWNERS MAY ELECT TO REPLACE THEIR EXISTING WINDOWS/DOORS. REPLACEMENT HARDWARE SHALL BE PER THE SCHEDULES AND GUIDELINES ON THE ARCHITECTURAL DRAWINGS BY SCOTT DYER ARCHITECTS. AS A COMPONENT OF WINDOW/DOOR REPLACEMENT, STORM SHUTTERS SHALL BE REMOVED. WINDOW/DOOR REPLACEMENT MASONRY OPENINGS WILL BE WATERPROOFED IN ACCORDANCE WITH S2C-3.3.
 - AFTER ALL CONCRETE REPAIRS AT UNIT BALCONIES HAVE BEEN COMPLETED THE CONTRACTOR SHALL CONDUCT A WATER TEST AND PROVIDE AN EPoxy/BIASD LEVELING COAT AS REQUIRED TO ELIMINATE PONDING. FINISH ALL BALCONIES WITH A TRAFFIC BEARING MEMBRANE PER SHEET TBM-1.
 - SEE BID FORM FOR ALL OTHER ITEMS NOTE SHOWN ON PLAN.

No.	Date	Revisions


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Date: 04/26/21
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Sheet Title:
LEVEL 12 FLOOR PLAN

Sheet No.:
A2C-1.3

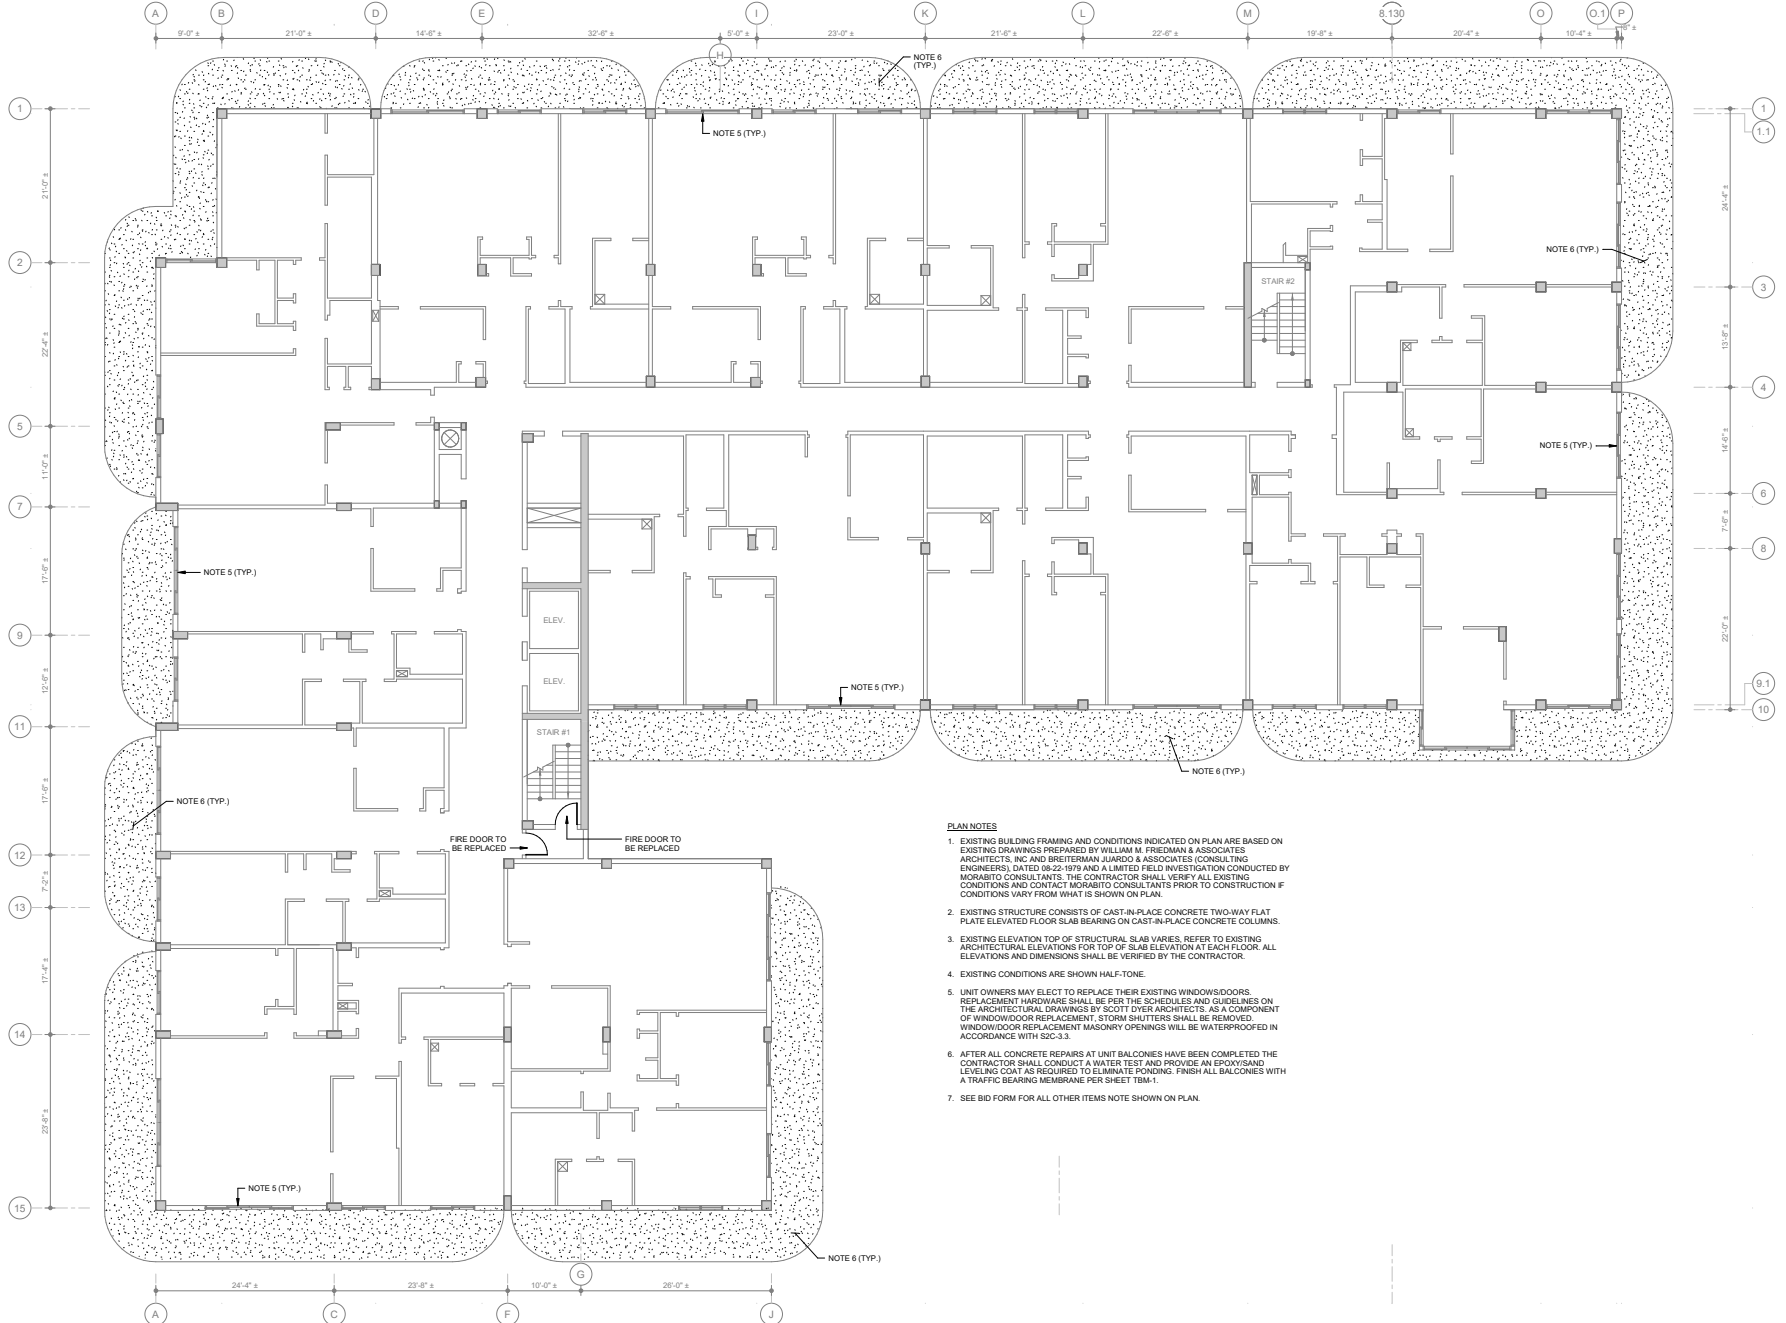

- PLAN NOTES**
- EXISTING BUILDING FRAMING AND CONDITIONS INDICATED ON PLAN ARE BASED ON EXISTING DRAWINGS PREPARED BY WILLIAM M. FREDMAN & ASSOCIATES ARCHITECTS, INC. AND BREITERMAN JUARDO & ASSOCIATES (CONSULTING ENGINEERS) DATED 08/22/19 AND A LIMITED FIELD INVESTIGATION CONDUCTED BY MORABITO CONSULTANTS. THE CONTRACTOR SHALL VERIFY ALL EXISTING CONDITIONS AND CONTACT MORABITO CONSULTANTS PRIOR TO CONSTRUCTION IF CONDITIONS VARY FROM WHAT IS SHOWN ON PLAN.
 - EXISTING STRUCTURE CONSISTS OF CAST-IN-PLACE CONCRETE TWO-WAY FLAT PLATE ELEVATED FLOOR SLAB BEARING ON CAST-IN-PLACE CONCRETE COLUMNS.
 - EXISTING ELEVATION TOP OF STRUCTURAL SLAB VARIES. REFER TO EXISTING ARCHITECTURAL ELEVATIONS FOR TOP OF SLAB ELEVATION AT EACH FLOOR. ALL ELEVATIONS AND DIMENSIONS SHALL BE VERIFIED BY THE CONTRACTOR.
 - EXISTING CONDITIONS ARE SHOWN HALF-TONE.
 - UNIT OWNERS MAY ELECT TO REPLACE THEIR EXISTING WINDOWS/DOORS. REPLACEMENT HARDWARE SHALL BE PER THE SCHEDULES AND GUIDELINES ON THE ARCHITECTURAL DRAWINGS BY SCOTT DYER ARCHITECTS. AS A COMPONENT OF WINDOW/DOOR REPLACEMENT, STORM SHUTTERS SHALL BE REMOVED. WINDOW/DOOR REPLACEMENT MASONRY OPENINGS WILL BE WATERPROOFED IN ACCORDANCE WITH S2C-3.3.
 - AFTER ALL CONCRETE REPAIRS AT UNIT BALCONIES HAVE BEEN COMPLETED THE CONTRACTOR SHALL CONDUCT A WATER TEST AND PROVIDE AN EPoxy/SPAN LEVELING COAT AS REQUIRED TO ELIMINATE PONDING. FINISH ALL BALCONIES WITH A TRAFFIC BEARING MEMBRANE PER SHEET TBM-1.
 - SEE BID FORM FOR ALL OTHER ITEMS NOTE SHOWN ON PLAN.

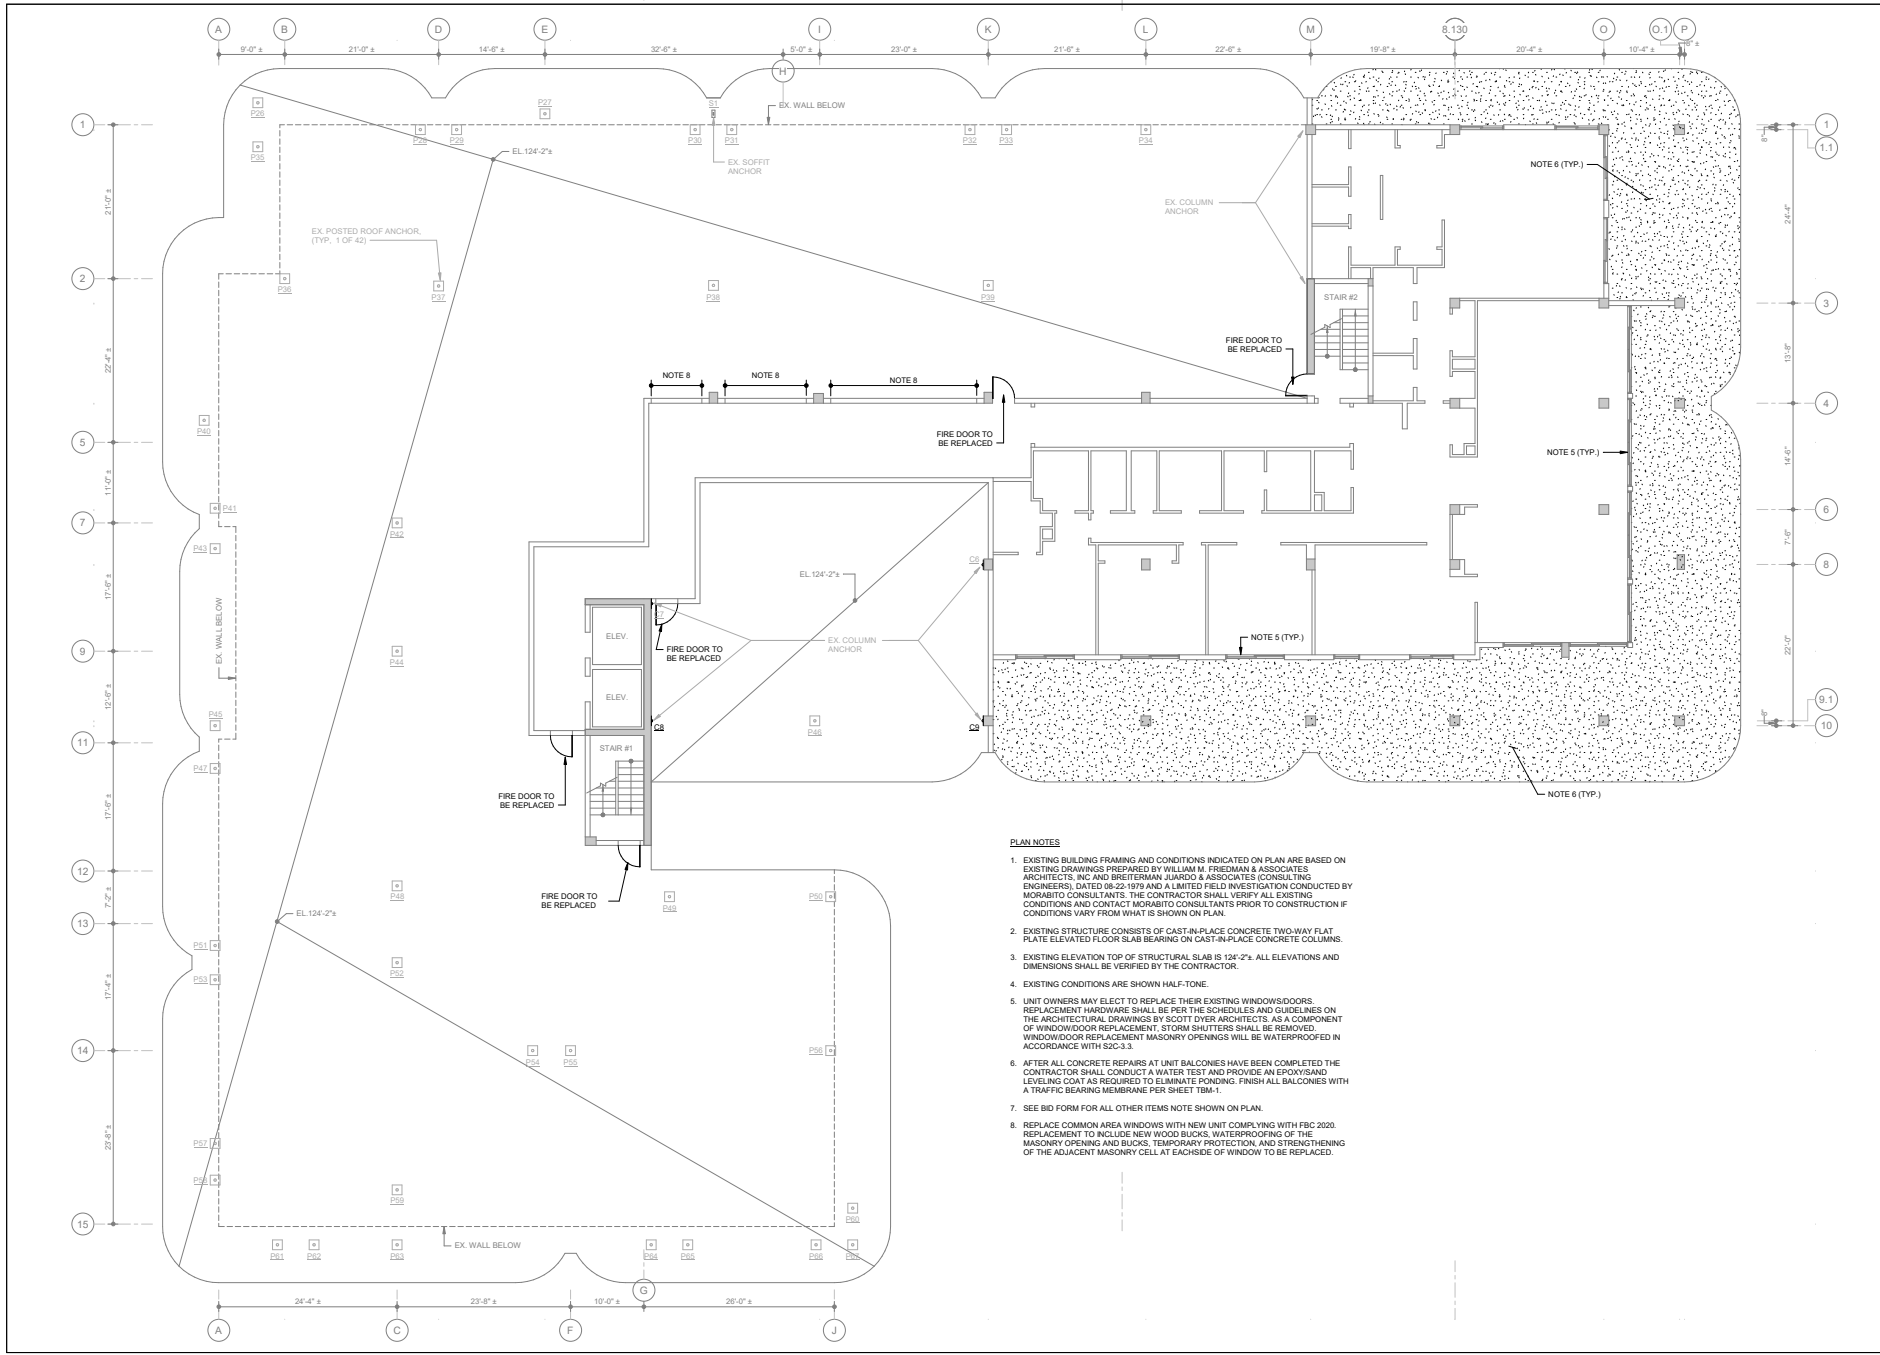

- PLAN NOTES**
- EXISTING BUILDING FRAMING AND CONDITIONS INDICATED ON PLAN ARE BASED ON EXISTING DRAWINGS PREPARED BY WILLIAM M. FRIEDMAN & ASSOCIATES ARCHITECTS, INC AND BREITERMAN JUARDO & ASSOCIATES CONSULTING ENGINEERS, DATED 06-22-1979 AND A LIMITED FIELD INVESTIGATION CONDUCTED BY MORABITO CONSULTANTS. THE CONTRACTOR SHALL VERIFY ALL EXISTING CONDITIONS AND CONTACT MORABITO CONSULTANTS PRIOR TO CONSTRUCTION IF CONDITIONS VARY FROM WHAT IS SHOWN ON PLAN.
 - EXISTING STRUCTURE CONSISTS OF CAST-IN-PLACE CONCRETE TWO-WAY FLAT PLATE ELEVATED FLOOR SLAB BEARING ON CAST-IN-PLACE CONCRETE COLUMNS.
 - EXISTING ELEVATION TOP OF STRUCTURAL SLAB IS 124'-2". ALL ELEVATIONS AND DIMENSIONS SHALL BE VERIFIED BY THE CONTRACTOR.
 - EXISTING CONDITIONS ARE SHOWN HALF-TONE.
 - UNIT OWNERS MAY ELECT TO REPLACE THEIR EXISTING WINDOWS/DOORS. REPLACEMENT HARDWARE SHALL BE PER THE SCHEDULES AND GUIDELINES ON THE ARCHITECTURAL DRAWINGS BY SCOTT DYER ARCHITECTS. AS A COMPONENT OF WINDOW/DOOR REPLACEMENT, STORM SHUTTERS SHALL BE REMOVED. WINDOW/DOOR REPLACEMENT MASONRY OPENINGS WILL BE WATERPROOFED IN ACCORDANCE WITH 5203.3.3.
 - AFTER ALL CONCRETE REPAIRS AT UNIT BALCONIES HAVE BEEN COMPLETED THE CONTRACTOR SHALL CONDUCT A WATER TEST AND PROVIDE AN EPOXY/SAND LEVELING COAT AS REQUIRED TO ELIMINATE PONDING. FINISH ALL BALCONIES WITH A TRAFFIC BEARING MEMBRANE PER SHEET TBM-1.
 - SEE BID FORM FOR ALL OTHER ITEMS NOTE SHOWN ON PLAN.
 - REPLACE COMMON AREA WINDOWS WITH NEW UNIT COMPLYING WITH FBC 2020. REPLACEMENT TO INCLUDE NEW WOOD BUCKS, WATERPROOFING OF THE MASONRY OPENING AND BUCKS, TEMPORARY PROTECTION, AND STRENGTHENING OF THE ADJACENT MASONRY CELL AT EACH SIDE OF WINDOW TO BE REPLACED.

CHAMPLAIN TOWERS SOUTH CONDOMINIUM
 8777 COLLINS AVENUE
 SURFSIDE, FLORIDA 33164

**CHAMPLAIN TOWERS SOUTH 40-YEAR BUILDING
 REPAIR & RESTORATION**
**PHASE IIC: OVERALL BUILDING
 REPAIR AND RESTORATION**

SEAL License 96025
 Expires 03/2023

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 Date: 04/26/21
 Scale: 1/8" = 1'-0"
 Sheet Title: LOW ROOF & PENTHOUSE FLOOR PLAN

Sheet No.:
A2C-1.4


No.	Date	Revisions

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DRAWN: HR/JB/RM
CHECKED: RM
APPROVED: FPM


Project No.: 18217
Date: 04/26/21
Scale: 1/8" = 1'-0"

Sheet Title:
PENTHOUSE AND HIGH
ROOF PLAN

Sheet No.:
A2C-1.5

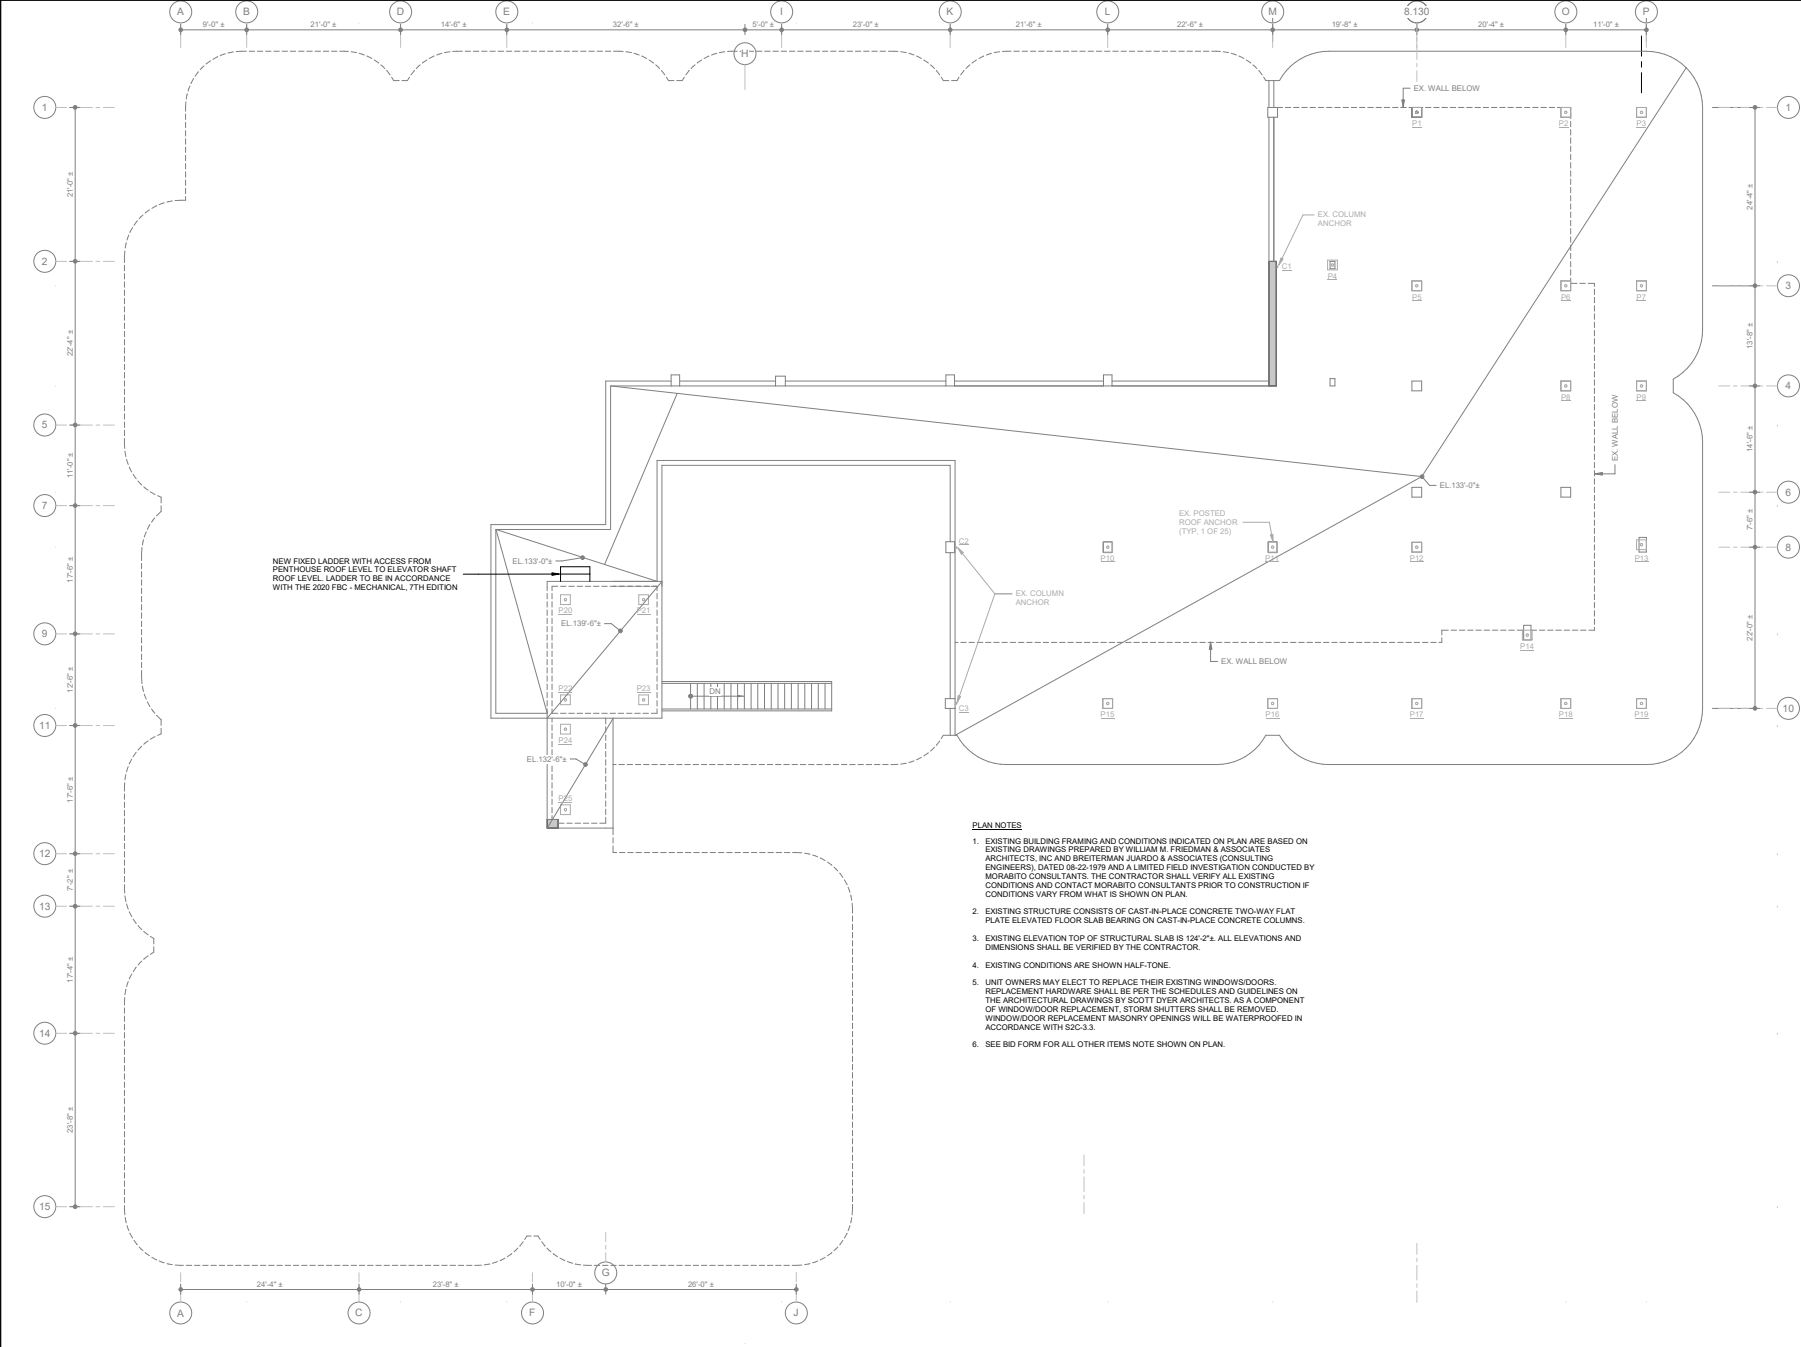

- PLAN NOTES**
1. EXISTING BUILDING FRAMING AND CONDITIONS INDICATED ON PLAN ARE BASED ON EXISTING DRAWINGS PREPARED BY WILLIAM M. FRIEDMAN & ASSOCIATES ARCHITECTS, INC AND BREITERMAN JUARDO & ASSOCIATES CONSULTING ENGINEERS, DATED 06-22-1979 AND A LIMITED FIELD INVESTIGATION CONDUCTED BY MORABITO CONSULTANTS. THE CONTRACTOR SHALL VERIFY ALL EXISTING CONDITIONS AND CONTACT MORABITO CONSULTANTS PRIOR TO CONSTRUCTION IF CONDITIONS VARY FROM WHAT IS SHOWN ON PLAN.
 2. EXISTING STRUCTURE CONSISTS OF CAST-IN-PLACE CONCRETE TWO-WAY FLAT PLATE ELEVATED FLOOR SLAB BEARING ON CAST-IN-PLACE CONCRETE COLUMNS.
 3. EXISTING ELEVATION TOP OF STRUCTURAL SLAB IS 124'-2". ALL ELEVATIONS AND DIMENSIONS SHALL BE VERIFIED BY THE CONTRACTOR.
 4. EXISTING CONDITIONS ARE SHOWN HALF-TONE.
 5. UNIT OWNERS MAY ELECT TO REPLACE THEIR EXISTING WINDOW/DOORS. REPLACEMENT HARDWARE SHALL BE PER THE SCHEDULES AND SCHEDULES ON THE ARCHITECTURAL DRAWINGS BY SCOTT DYER ARCHITECTS. AS A COMPONENT OF WINDOW/DOOR REPLACEMENT, STORM SHUTTERS SHALL BE REMOVED. WINDOW/DOOR REPLACEMENT MASONRY OPENINGS WILL BE WATERPROOFED IN ACCORDANCE WITH S2C-3.3.
 6. SEE BID FORM FOR ALL OTHER ITEMS NOTE SHOWN ON PLAN.

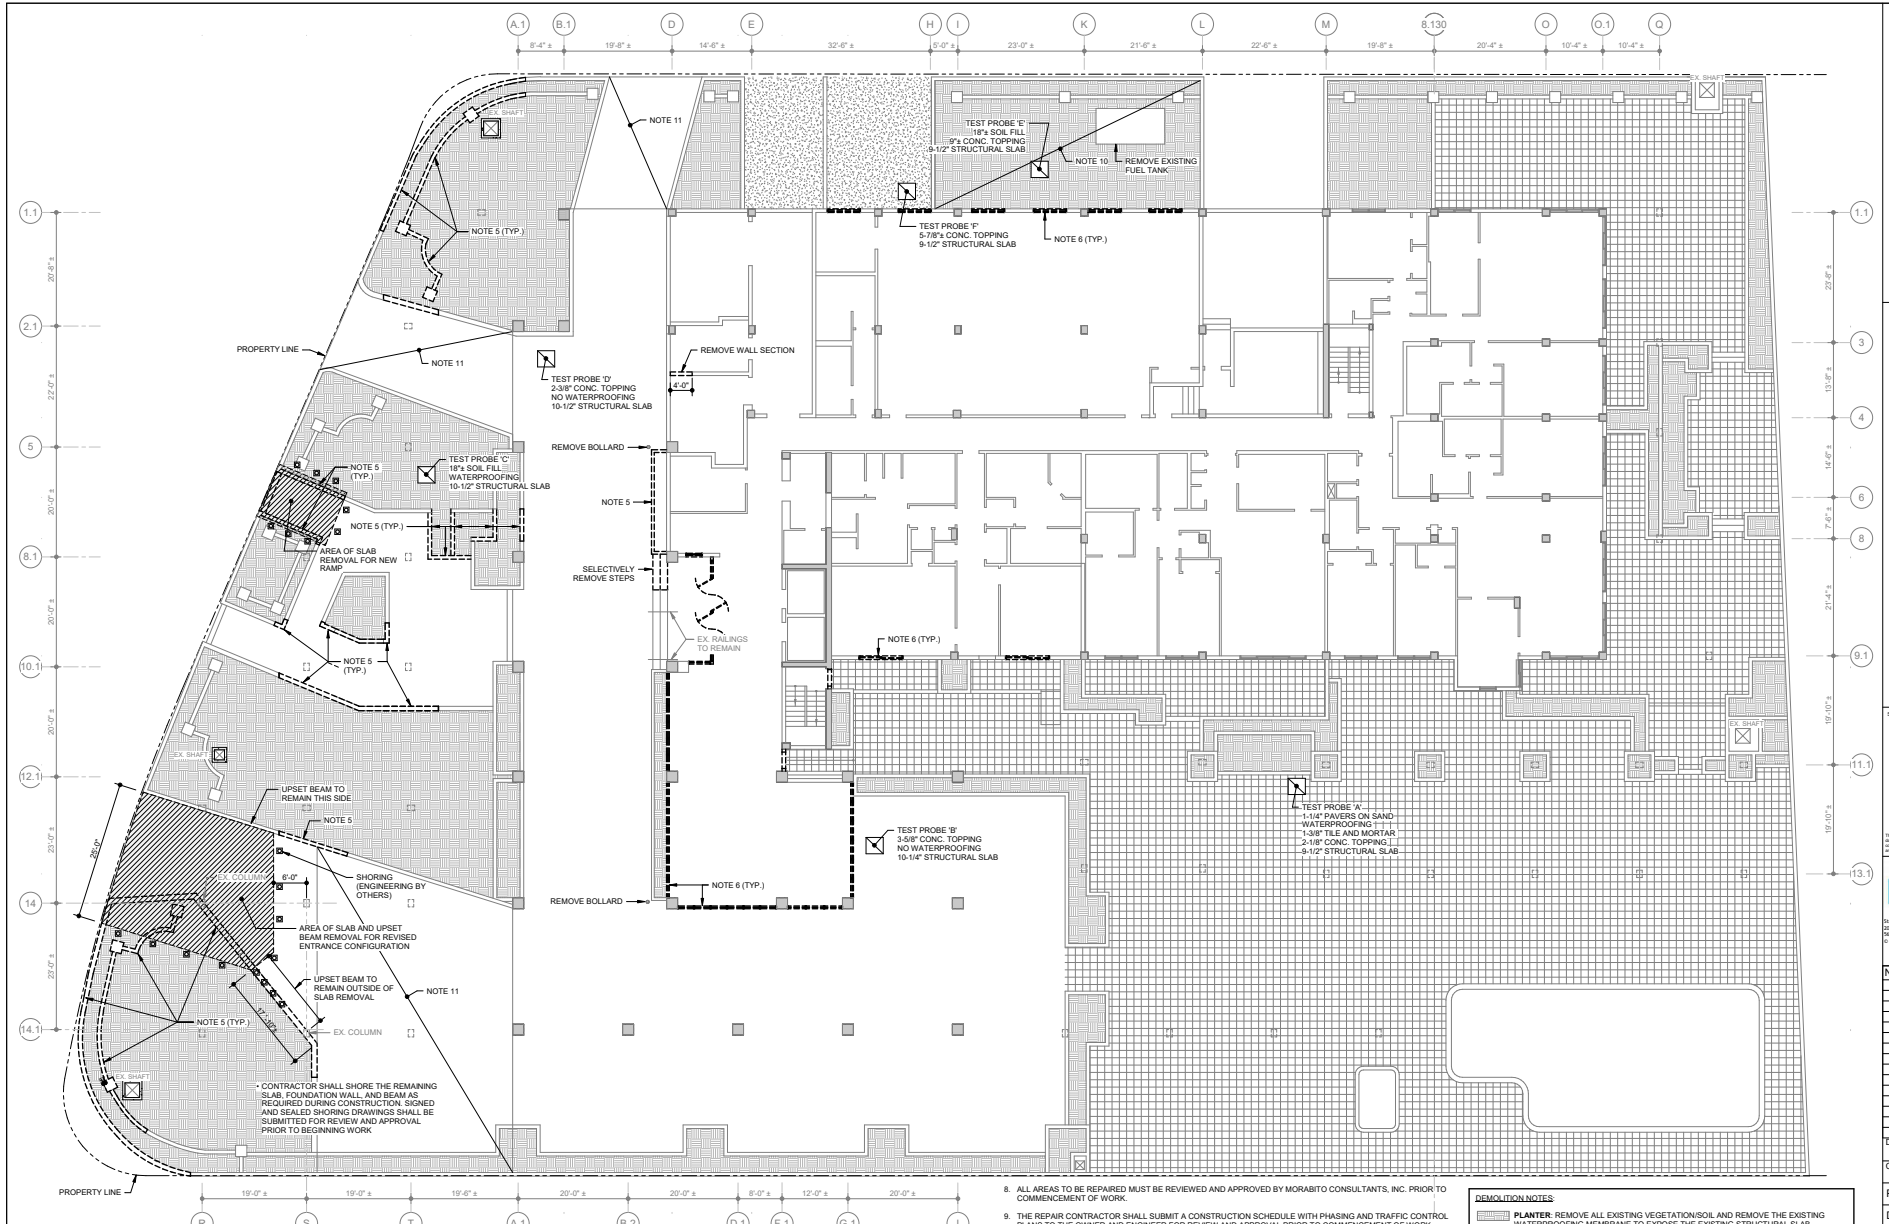

- PLAN NOTES**
- EXISTING BUILDING FRAMING AND CONDITIONS INDICATED ON PLAN ARE BASED ON EXISTING DRAWINGS PREPARED BY WILLIAM M. FRIEDMAN & ASSOCIATES ARCHITECTS, INC. AND BRISTLEMAN JARARD & ASSOCIATES, DATED 08-22-1975 AND A LIMITED FIELD INVESTIGATION CONDUCTED BY MORABITO CONSULTANTS. CONTRACTOR SHALL VERIFY ALL EXISTING CONDITIONS AND CONTACT MORABITO CONSULTANTS PRIOR TO CONSTRUCTION IF CONDITIONS VARY FROM WHAT IS SHOWN ON PLAN.
 - EXISTING STRUCTURE CONSISTS OF CAST-IN-PLACE CONCRETE TWO-WAY FLAT PLATE ELEVATED FLOOR SLAB BEARING ON CAST-IN-PLACE CONCRETE COLUMNS.
 - EXISTING ELEVATION TOP OF STRUCTURAL SLAB VARIES. SEE STRUCTURAL PLAN SZC-1.0 FOR ELEVATIONS OF THE FIRST FLOOR SLAB.
 - EXISTING CONDITIONS ARE SHOWN HALF-TONE.
 - EXISTING PLANTER/MASONRY WALLS TO BE REMOVED ARE NOTED ON PLAN THIS: [Symbol]
 - INSTALL TEMPORARY WEATHER WALLS AND REMOVE GLASS WINDOWS AND DOORS AT FIRST FLOOR COMMON AREAS AS NOTED ON PLAN.
 - ONCE ALL DEMOLITION IS COMPLETE AND THE EXISTING STRUCTURAL SLAB IS EXPOSED, THE ENTIRE CONCRETE STRUCTURE SHALL BE SURVEYED AND ALL DETERIORATED CONCRETE SHALL BE NOTED BY THE CONTRACTOR AS PART OF THEIR WORK.

- ALL AREAS TO BE REPAIRED MUST BE REVIEWED AND APPROVED BY MORABITO CONSULTANTS, INC. PRIOR TO COMMENCEMENT OF WORK.
 - THE REPAIR CONTRACTOR SHALL SUBMIT A CONSTRUCTION SCHEDULE WITH PHASING AND TRAFFIC CONTROL PLANS TO THE OWNER AND ENGINEER FOR REVIEW AND APPROVAL PRIOR TO COMMENCEMENT OF WORK.
 - FOR FINAL ACCEPTANCE OF WORK THE CONTRACTOR SHALL PREPARE AND SUBMIT DIGITAL AS BUILTS WITH PHOTO LOGS OF ALL WORK COMPLETED.
 - THE PLANTER AREA ALONG 88TH STREET INDICATED ON PLAN (IN ADDITION TO REMOVAL OF THE VEGETATION, SOIL, AND WATERPROOFING) REQUIRES REMOVAL OF THE EXISTING CONCRETE TOPPING SLAB TO EXPOSE THE EXISTING STRUCTURAL SLAB.
 - AFTER STAMPED CONCRETE REMOVAL, REMOVE EXISTING FILL TO EXPOSE THE EXISTING STRUCTURAL SLAB AT THE LOCATIONS NOTED ON PLAN.
 - SEE BID FORM FOR ALL OTHER ITEMS NOTE SHOWN ON PLAN.
- DEMOLITION NOTES:**
- [Symbol] **PLANTER:** REMOVE ALL EXISTING VEGETATION/SOIL AND REMOVE THE EXISTING WATERPROOFING MEMBRANE TO EXPOSE THE EXISTING STRUCTURAL SLAB.
 - [Symbol] **STAMPED CONCRETE:** REMOVE STAMPED CONCRETE TOPPING TO EXPOSE THE EXISTING STRUCTURAL SLAB.
 - [Symbol] **POOL DECK/PRIVATE BALCONIES:** REMOVE ALL EXISTING PAVERS AND SAND SETTING BED, WATERPROOFING MEMBRANE, ABANDONED TILE AND MORTAR LAYER, AND CONCRETE TOPPING SLAB TO EXPOSE THE EXISTING STRUCTURAL SLAB.
 - [Symbol] **EXPOSED CONCRETE SURFACE:** REMOVE EXISTING CONCRETE TOPPING SLAB TO EXPOSE THE EXISTING STRUCTURAL SLAB.
- **SEE TEST PROBES NOTED ON PLAN FOR EXISTING CONDITIONS****

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**PHASE IC: OVERALL BUILDING
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No.	Date	Revisions

DESIGNED	HR/JB/RM	DRAWN	HR/JB/RM
CHECKED	RM	APPROVED	PPM
Project No.:	18217		
Date:	04/26/21		
Scale:	3/32" = 1'-0"		
Sheet Title:	LEVEL 1 DEMO PLAN		
Sheet No.:	D2C-1.0		


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CHECKED: **RM** APPROVED: **FPM**


Project No.: 18217
Date: 04/26/21
Scale: 3/32" = 1'-0"

Sheet Title:
**LEVEL 1 SLAB
REINFORCEMENT AND
FRAMING PLAN**

Sheet No.:
S2C-1.0

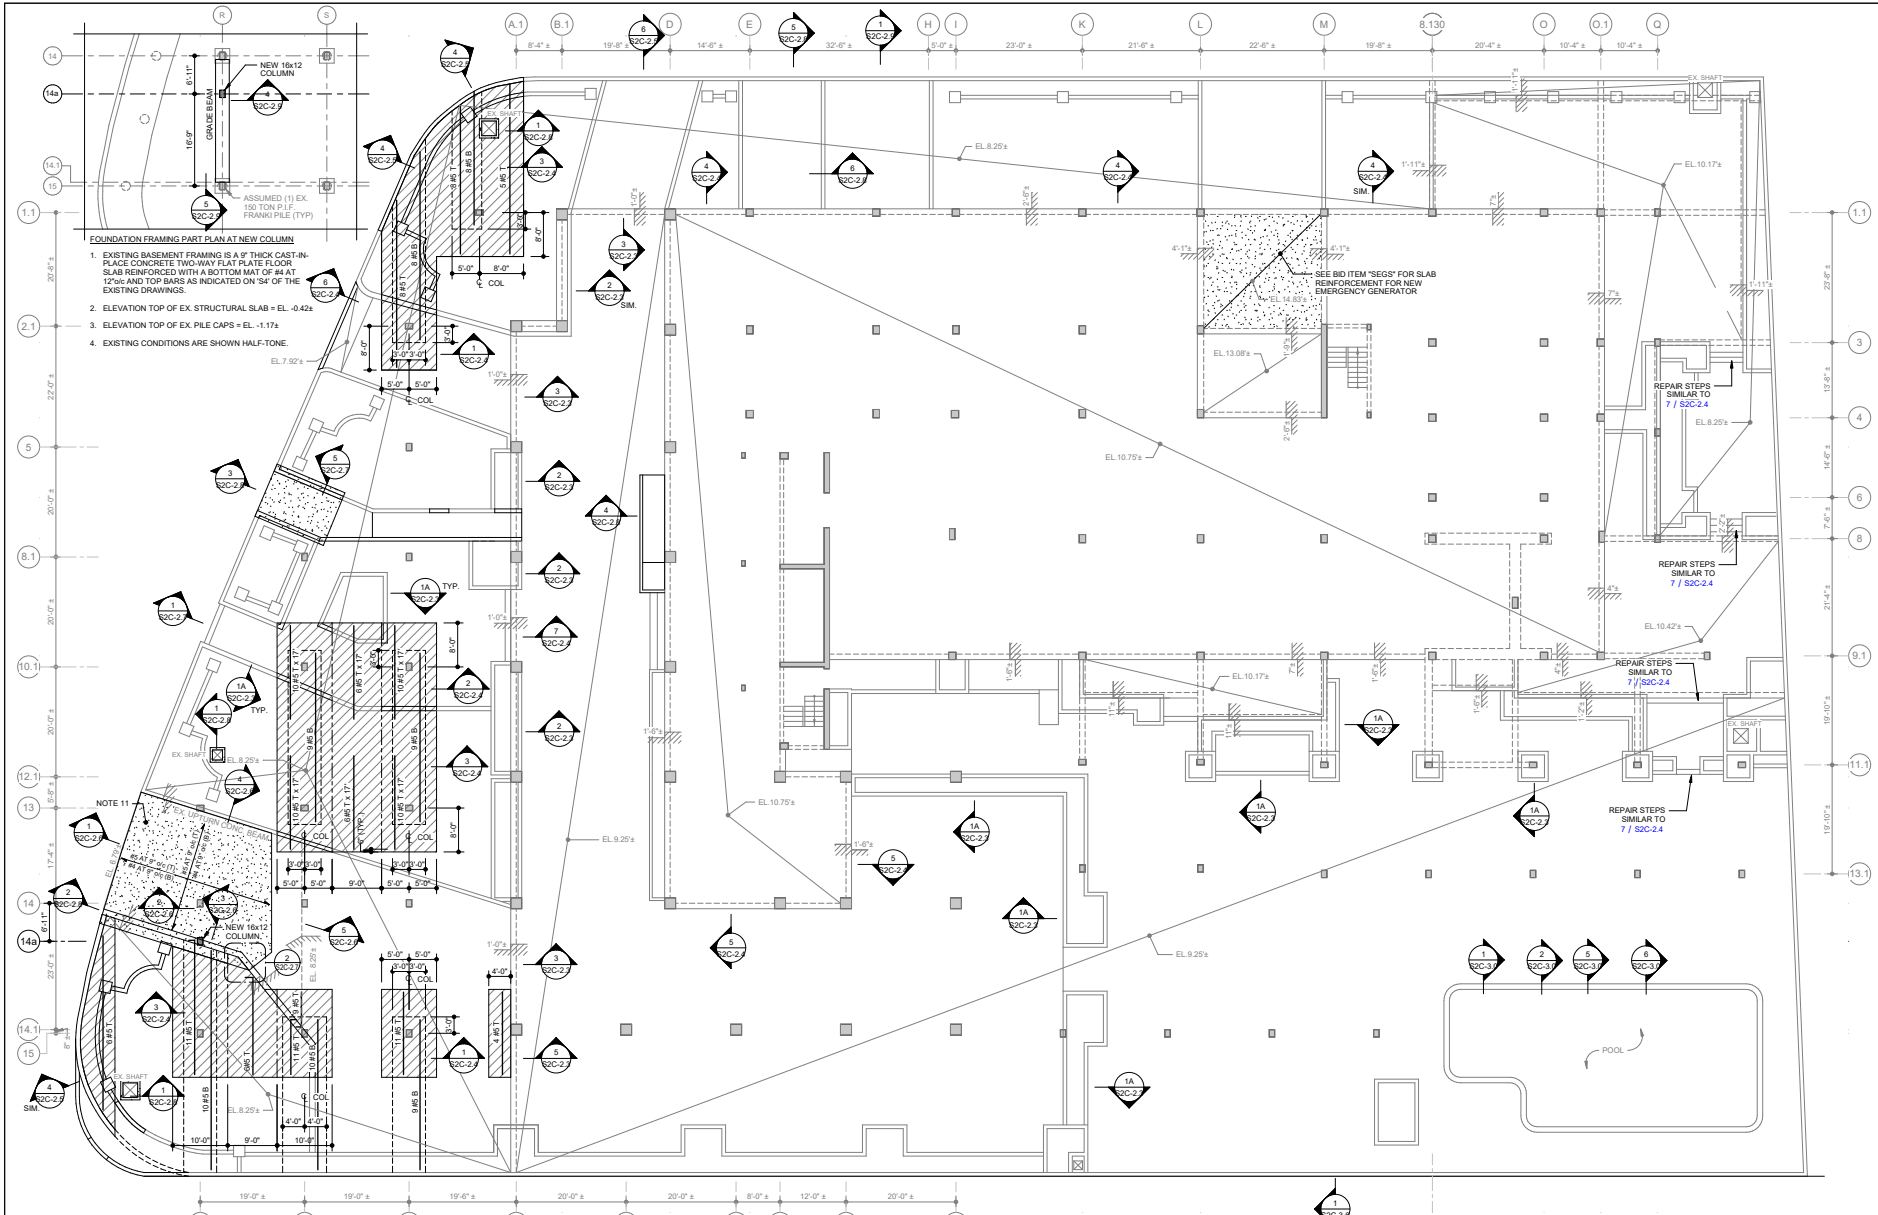

- PLAN NOTES**
- EXISTING BUILDING FRAMING AND CONDITIONS INDICATED ON PLAN ARE BASED ON EXISTING DRAWINGS PREPARED BY WILLIAM M. FRIEDMAN & ASSOCIATES ARCHITECTS, INC. AND BRIETEBRAN, JUARRO & ASSOCIATES (CONSULTING ENGINEERS), DATED 08-22-1979 AND A LIMITED FIELD INVESTIGATION CONDUCTED BY MORABITO CONSULTANTS. THE CONTRACTOR SHALL VERIFY ALL EXISTING CONDITIONS AND CONTACT MORABITO CONSULTANTS PRIOR TO CONSTRUCTION IF CONDITIONS VARY FROM WHAT IS SHOWN ON PLAN.
 - EXISTING FIRST FLOOR (LOBBY LEVEL) FRAMING IS A 12" THICK CAST-IN-PLACE CONCRETE TWO-WAY FLAT PLATE FLOOR SLAB REINFORCED WITH A BOTTOM MAT OF #4 AT 12" AND TOP BARS AS INDICATED ON 'S2' OF THE EXISTING DRAWINGS.
 - EXISTING CONDITIONS ARE SHOWN HALF-TONE.
 - EXISTING ELEVATION TOP OF STRUCTURAL SLAB VARIES. REFER TO PLAN FOR TOP OF SLAB ELEVATIONS. ALL ELEVATIONS AND DIMENSIONS SHALL BE VERIFIED BY THE CONTRACTOR.
 - SEE SHEET S2C-1.0 FOR NEW CMU WALL LOCATIONS
 - CONCRETE WALLS THAT ARE SUPPORTING EARTH MUST BE ALLOWED TO CURE FOR 7 DAYS PRIOR TO PLACING ANY RETAINED EARTH.
 - FOR ELEVATION TOP OF EXISTING FINISHED SURFACES, REFER TO BOUNDARY SURVEY BY J. BONFILL & ASSOCIATES, INC. DATED AUGUST 7, 2020.
 - FULLY BONDED CONCRETE OVERLAY AREAS ARE NOTED ON PLAN THUS [STIPPLED PATTERN]. BONDED OVERLAYS SHALL BE A MINIMUM OF 2" THICK AND REINFORCED AS INDICATED ON PLAN. REINFORCEMENT SHALL BE EVENLY SPACED ACROSS THE WIDTH OF THE BONDED OVERLAY. REFER TO ELEVATIONS PROVIDED ON S2C-1.1 FOR ELEVATION TOP OF BONDED CONCRETE OVERLAYS.
 - ALL REMAINING EXPOSED CONCRETE AREAS NOT SPECIFICALLY NOTED AS FULLY BONDED SHALL RECEIVE CONCRETE TOPPING TO ACHIEVE REQUIRED ELEVATIONS AND SLOPE FOR DRAINAGE. REFER TO SPOT ELEVATIONS PROVIDED ON S2C-1.1 FOR ELEVATION TOP OF CONCRETE TOPPING.
 - DROP PANEL LOCATIONS ARE INDICATED ON PLAN THUS [DASHED LINE]. DROPS PANEL DEPTH SHALL BE A 4" PROJECTION BELOW THE BOTTOM OF THE SLAB. DROPS SHALL BE REINFORCED AS INDICATED ON PLAN. REINFORCEMENT SHALL BE EVENLY SPACED ACROSS THE WIDTH OF THE DROP PANEL.
 - NEW ENTRANCE DRIVE RAMP SLAB SHALL BE 9-12" MINIMUM THICK REINFORCED CONCRETE SLAB (FC = 4,000 PSI) WITH MAXIMUM W/C RATIO OF 0.42. REINFORCEMENT AS SHOWN ON PLAN. THE EXISTING SLAB REINFORCEMENT INTO NEW CONCRETE PER DETAILS.
 - ONCE CONCRETE REPAIRS AND PLACEMENT OF BONDED OVERLAYS AND TOPPING HAVE BEEN COMPLETED, THE HOT APPLIED WATERPROOFING SYSTEM SHALL BE APPLIED OVER THE ENTIRE DECK PER APPROVED DETAILS. IMMEDIATELY PROTECT WATERPROOFING WITH PROTECTION BOARD, INSTALLED PER MANUFACTURERS REQUIREMENTS.
 - SEE BID FORM FOR ALL OTHER ITEMS NOTE SHOWN ON PLAN.

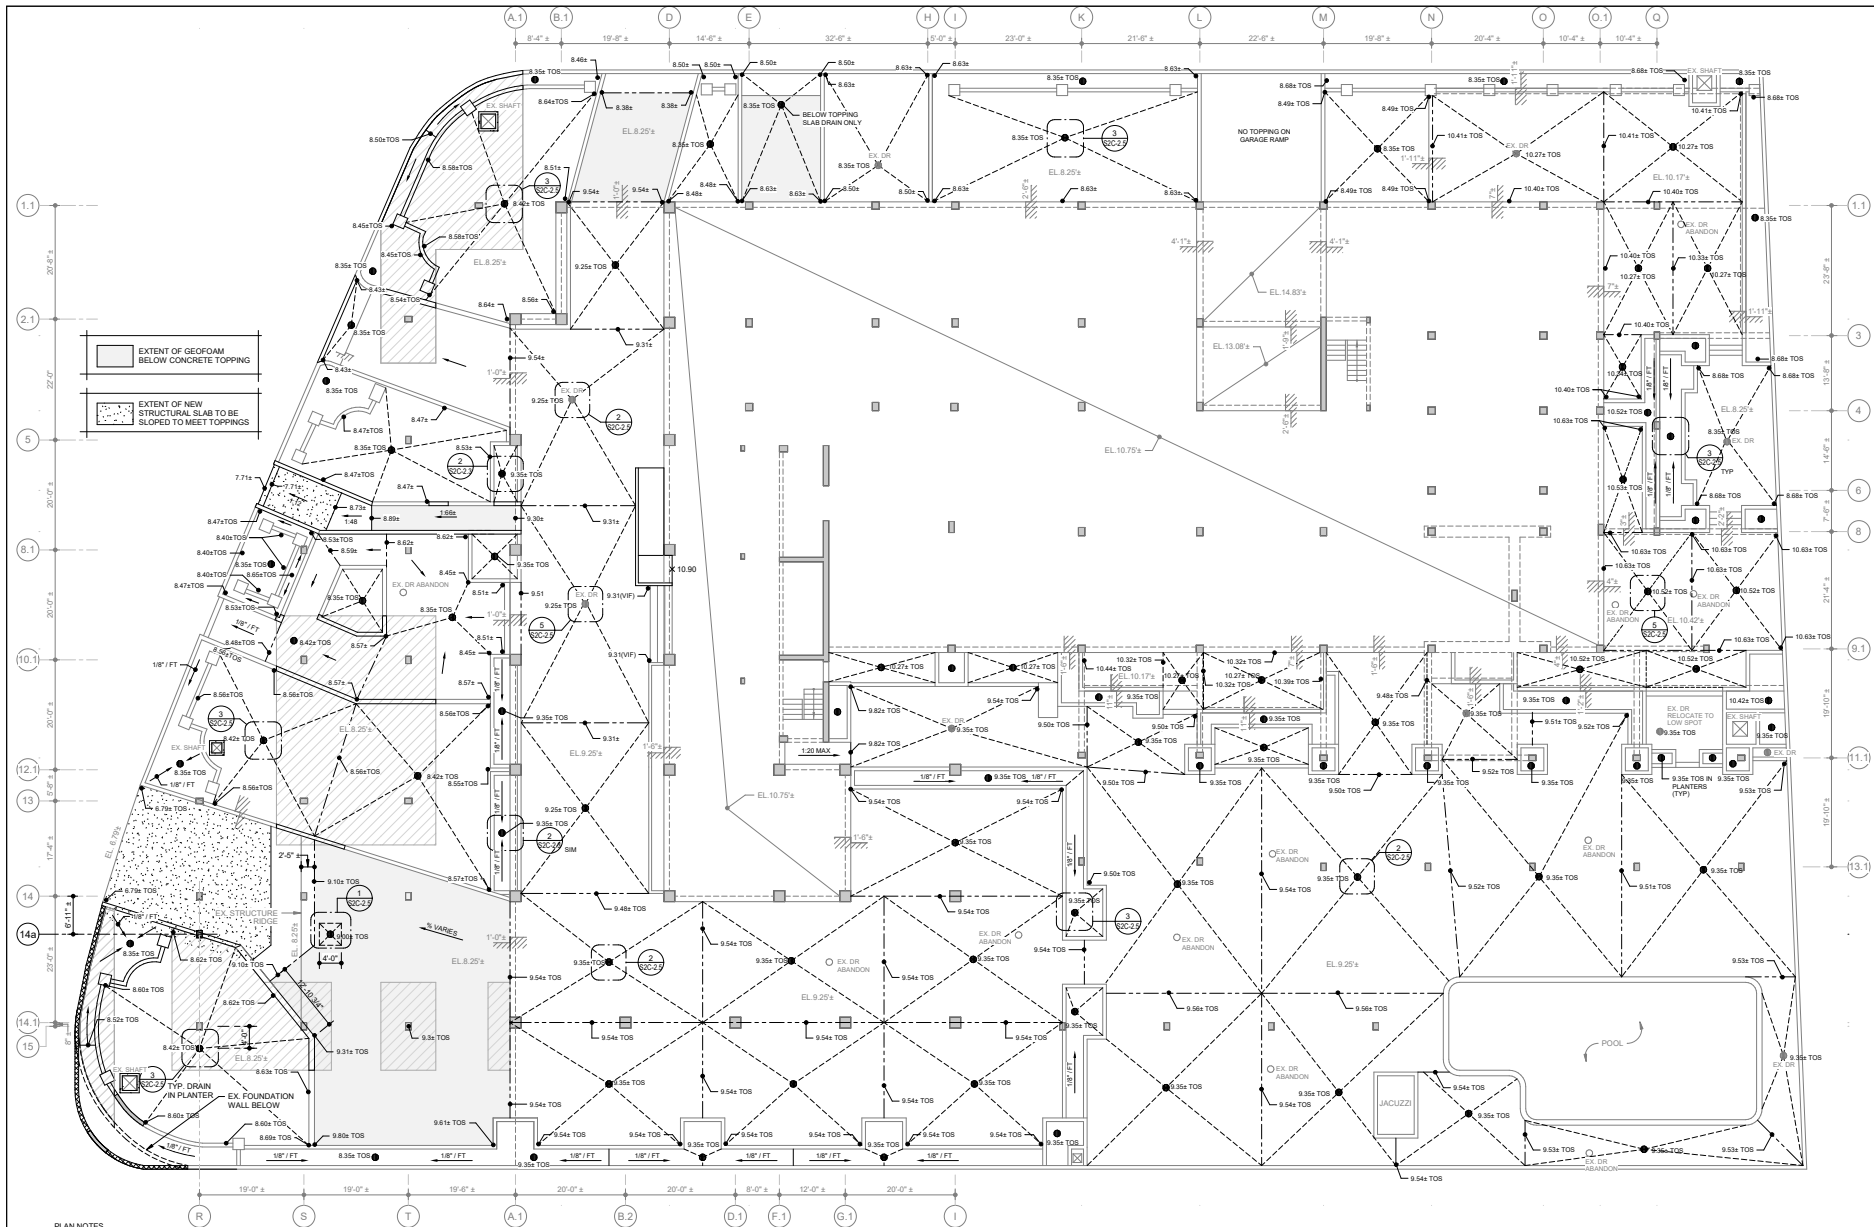

PLAN NOTES

- EXISTING BUILDING FRAMING AND CONDITIONS INDICATED ON PLAN ARE BASED ON EXISTING DRAWINGS PREPARED BY WILLIAM M. FREEDMAN & ASSOCIATES ARCHITECTS, INC AND BREIFERMAN JUARDO & ASSOCIATES (CONSULTING ENGINEERS), DATED 08-22-199 AND A LIMITED FIELD INVESTIGATION CONDUCTED BY MORABITO CONSULTANTS. THE CONTRACTOR SHALL VERIFY ALL EXISTING CONDITIONS AND CONTACT MORABITO CONSULTANTS PRIOR TO CONSTRUCTION IF CONDITIONS VARY FROM WHAT IS SHOWN ON PLAN.
- EXISTING FIRST FLOOR (LOBBY LEVEL) FRAMING IS A 9 1/2" THICK CAST-IN-PLACE CONCRETE TWO-WAY FLAT PLATE FLOOR SLAB REINFORCED WITH A BOTTOM MAT OF #4 AT 12" ON AND TOP BARS AS INDICATED ON 35 OF THE EXISTING DRAWINGS.
- EXISTING CONDITIONS ARE SHOWN HALF-TONE.
- EXISTING ELEVATION TOP OF STRUCTURAL SLAB VARIES AS INDICATED. ALL ELEVATIONS AND DIMENSIONS SHALL BE VERIFIED BY THE CONTRACTOR.
- FOR ELEVATION TOP OF EXISTING FINISHED SURFACES, REFER TO BOUNDARY SURVEY BY J. BONFILL & ASSOCIATES, INC. DATED AUGUST 7, 2020.
- FULLY BONDED CONCRETE OVERLAY AREAS ARE NOTED ON PLAN THUS [Symbol] SEE SHEET S2C-1-D FOR STRUCTURAL STRENGTHENING BONDED OVERLAY AREAS. STRUCTURE BONDED TOPPING AREAS SHALL BE CAST INTEGRALLY WITH TYPICAL SLOPED BONDED TOPPINGS
- ALL LANDSCAPE AND PLANTER AREAS NOT SPECIFICALLY NOTED TO HAVE 2" FULLY BONDED TOPPING PER NOTE 6 SHALL RECEIVE CONCRETE TOPPING TO ACHIEVE REQUIRED ELEVATIONS AND SLOPE FOR DRAINAGE. SPOT ELEVATIONS PROVIDED ON THIS SHEET FOR ELEVATION TOP OF CONCRETE TOPPINGS NOTED AS "X.XX" TOS. WHERE NO SPOT ELEVATIONS ARE PROVIDED, PROVIDE MINIMUM 1/8" PER FOOT SLOPE.
- ALL ABANDONED DRAINS SHALL BE SAW-CUT FROM SLAB AND REPAIRED FULL-DEPTH. NOTE THAT NOT ALL EXISTING PLANTER DRAIN LOCATIONS ARE KNOWN. WHERE FOUND, ABANDON AND REPAIR SLAB FULL-DEPTH.
- ONCE CONCRETE REPAIRS AND PLACEMENT OF BONDED OVERLAYS AND TOPPINGS HAVE BEEN COMPLETED, THE HOT APPLIED WATERPROOFING SYSTEM SHALL BE APPLIED OVER THE ENTIRE DECK PER APPROVED DETAILS. IMMEDIATELY PROTECT WATERPROOFING WITH PROTECTION BOARD, INSTALLED PER MANUFACTURERS REQUIREMENTS.
- SEE BID FORM FOR ALL OTHER ITEMS NOTE SHOWN ON PLAN.
- TOPPING SLAB SHALL HONOR ALL EXISTING FEATURES TO REMAIN (STEPS, SIDEWALK, BUILDING ENTRANCE, ETC.). CONTRACTOR TO ADJUST TOPPING SLAB TO ENSURE SMOOTH, CODE-COMPLIANT TRANSITIONS TO EXISTING CONDITIONS AT FINISHED SURFACE.
- LEVEL RIDGES TO BE UNIFORM ELEVATION ACROSS SHOWN AS: - - - - -
- SLOPED RIDGES BETWEEN DRAINAGE PLANES SHOWN AS: - - - - -

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Expiry: 03/31/2023



No.	Date	Revisions

DESIGNED: HR/JB/RM | DRAWN: HR/JB/RM
CHECKED: RM | APPROVED: FPM

Project No.: 18217
Date: 04/26/21

Sheet Title:
LEVEL 1 BONDED
OVERLAY AND TOPPING
ELEVATIONS


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No.	Date	Revisions

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CHECKED RM	APPROVED FPM


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Date: 04/26/21
Scale: 1/8" = 1'-0"
Sheet Title:
LEVEL 2 FRAMING PLAN

Sheet No.:
S2C-1.2

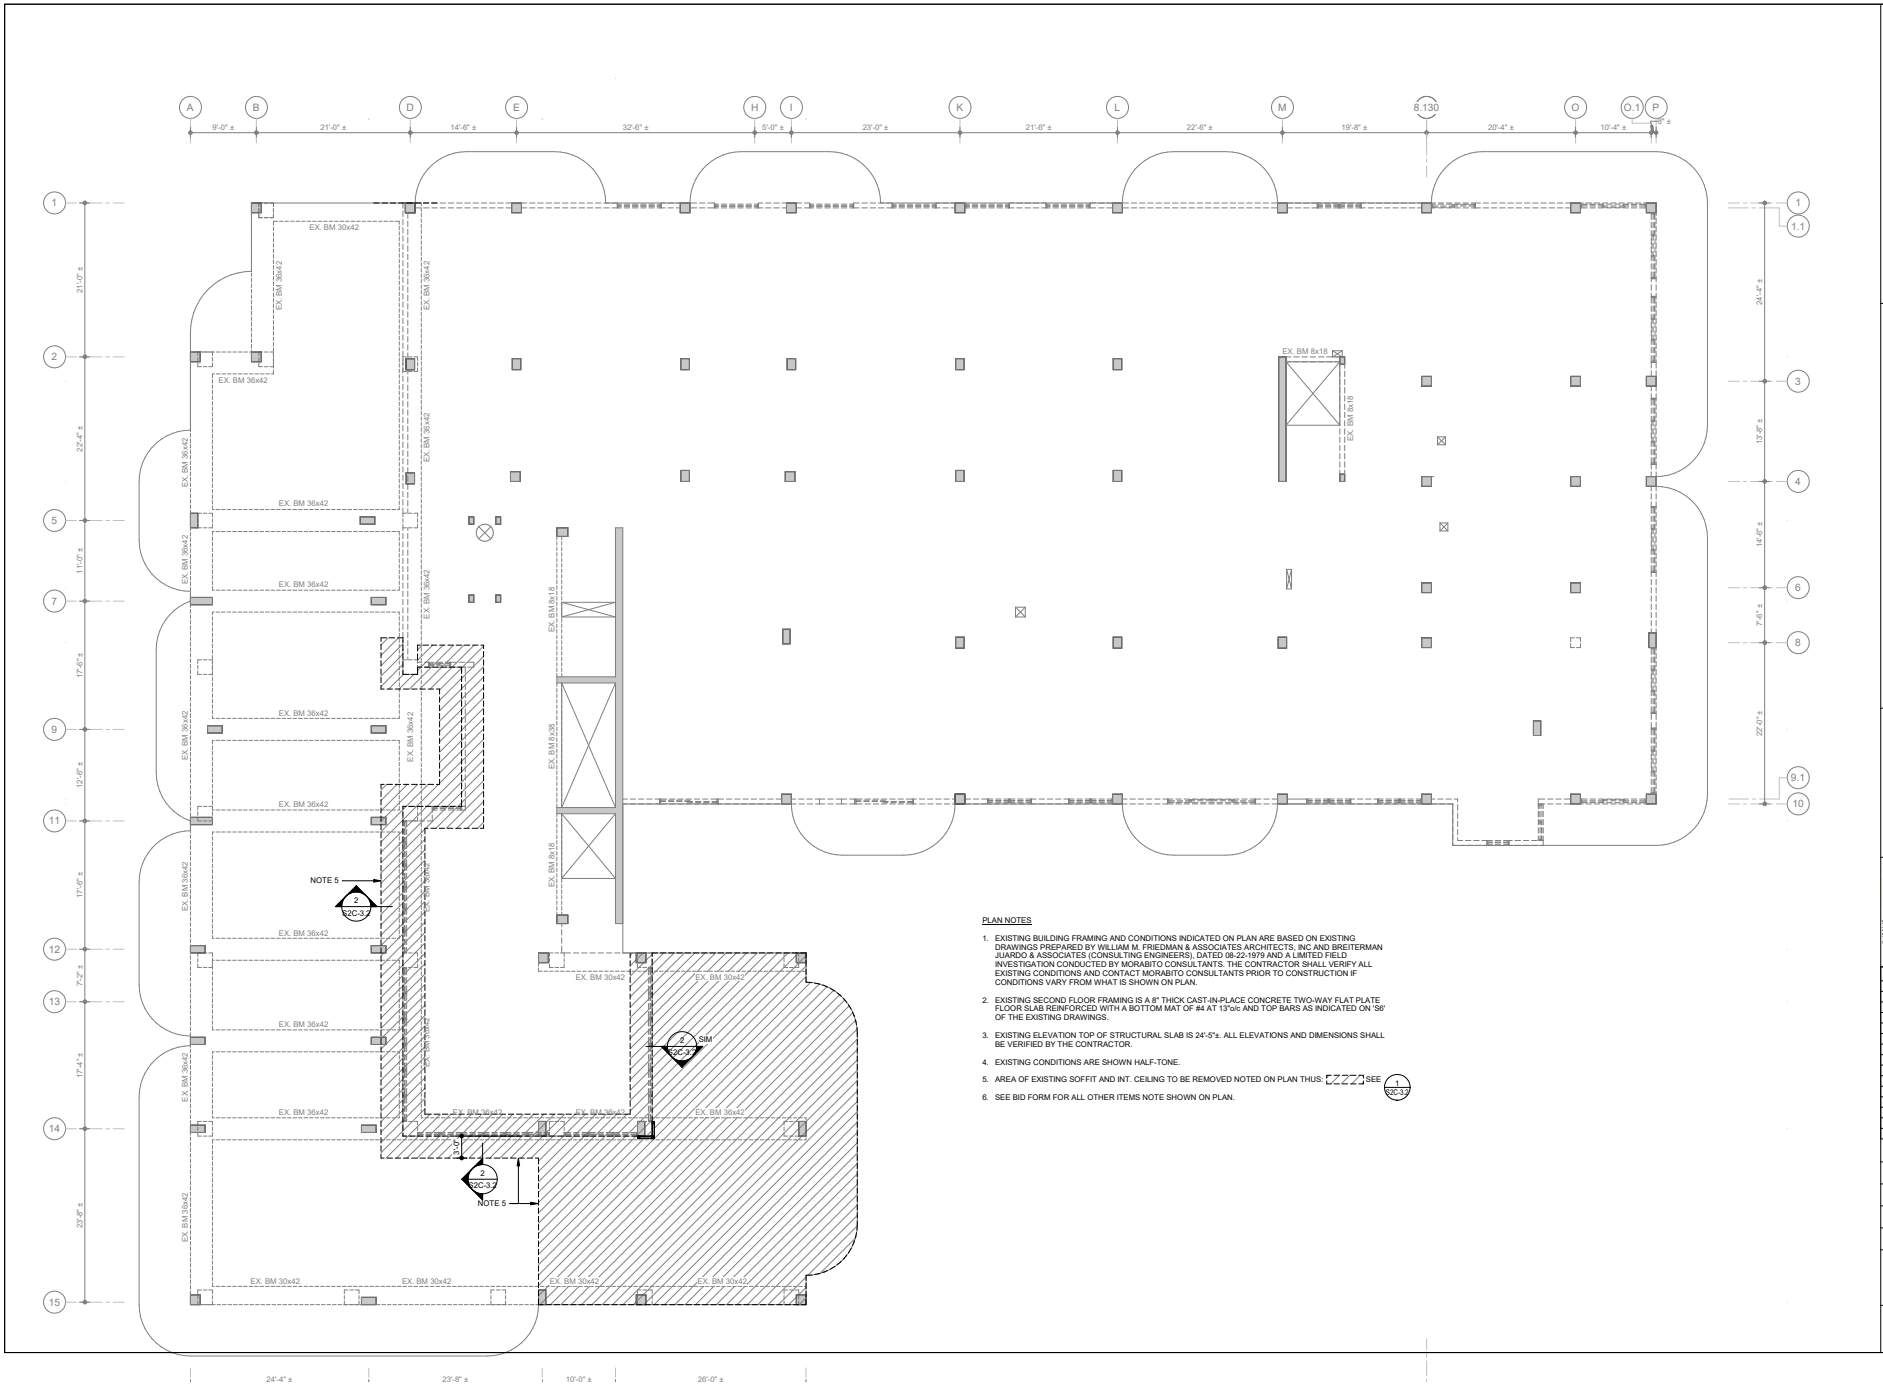


PLAN NOTES


- EXISTING BUILDING FRAMING AND CONDITIONS INDICATED ON PLAN ARE BASED ON EXISTING DRAWINGS PREPARED BY WILLIAM M. FRIEDMAN & ASSOCIATES ARCHITECTS, INC. AND BREITERMAN JUARDO & ASSOCIATES (CONSULTING ENGINEERS), DATED 08-22-1979 AND A LIMITED FIELD INVESTIGATION CONDUCTED BY MORABITO CONSULTANTS. THE CONTRACTOR SHALL VERIFY ALL EXISTING CONDITIONS AND CONTACT MORABITO CONSULTANTS PRIOR TO CONSTRUCTION IF CONDITIONS VARY FROM WHAT IS SHOWN ON PLAN.
- EXISTING SECOND FLOOR FRAMING IS 8" THICK CAST-IN-PLACE CONCRETE TWO-WAY FLAT PLATE FLOOR SLAB REINFORCED WITH A BOTTOM MAT OF #4 AT 13"OC AND TOP BARS AS INDICATED ON 'S6' OF THE EXISTING DRAWINGS.
- EXISTING ELEVATION TOP OF STRUCTURAL SLAB IS 24'-6". ALL ELEVATIONS AND DIMENSIONS SHALL BE VERIFIED BY THE CONTRACTOR.
- EXISTING CONDITIONS ARE SHOWN HALF-TONE.
- AREA OF EXISTING SOFFIT AND INT. CEILING TO BE REMOVED NOTED ON PLAN THUS: [ZZZZ] SEE [1] S2C-1.
- SEE BID FORM FOR ALL OTHER ITEMS NOTE SHOWN ON PLAN.

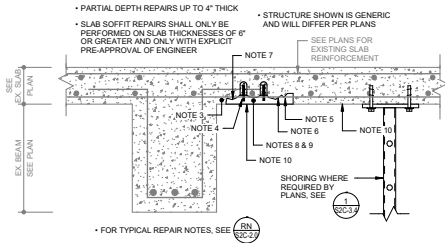


SU SLAB SOFFIT REPAIR
1 1/2" = 1'-0"

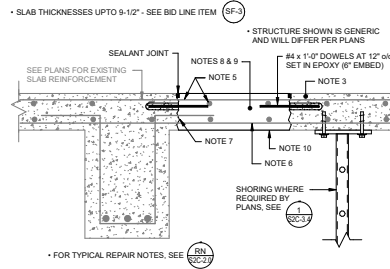


SF SLAB FULL-DEPTH REPAIR
1 1/2" = 1'-0"

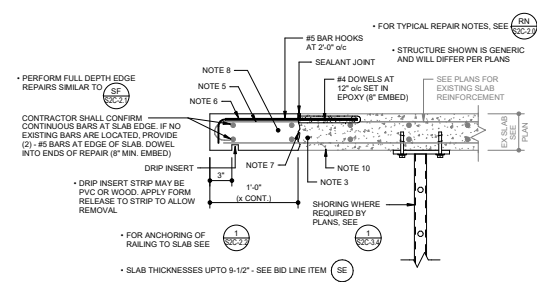


SE SLAB FULL-DEPTH DECK EDGE REPAIR
1 1/2" = 1'-0"

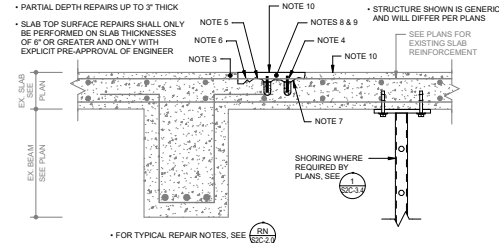


ST SLAB TOP SURFACE REPAIR
1 1/2" = 1'-0"

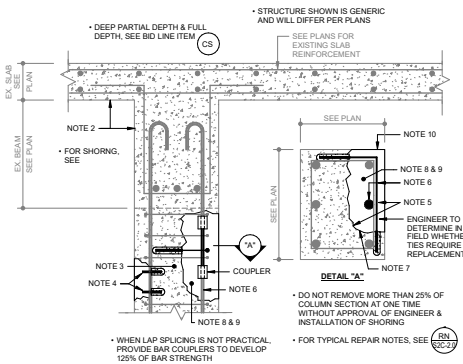


CS COLUMN SPALL REPAIR
1 1/2" = 1'-0"

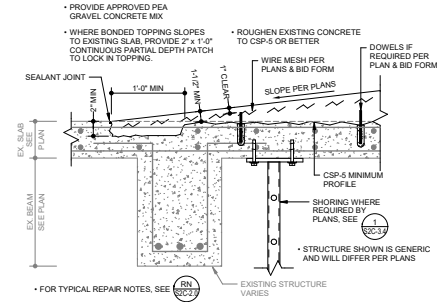

BT BONDED TOPPING TERMINATION
1 1/2" = 1'-0"

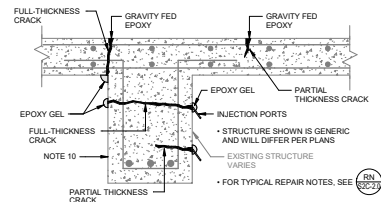

EI STRUCTURAL CRACK REPAIR (EPOXY INJECTION)
1 1/2" = 1'-0"

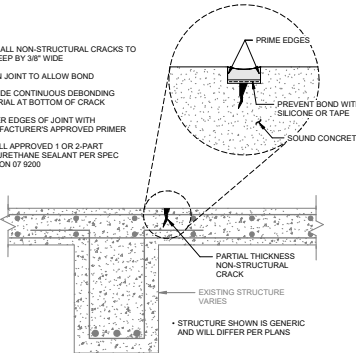

JS NON-STRUCTURAL CRACK REPAIR (CRACK SEALANT)
1 1/2" = 1'-0"

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PHASE 1C: OVERALL BUILDING
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SCALE: License: 90023
Expiry: 03/30/20

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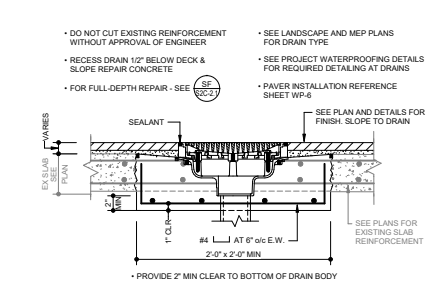
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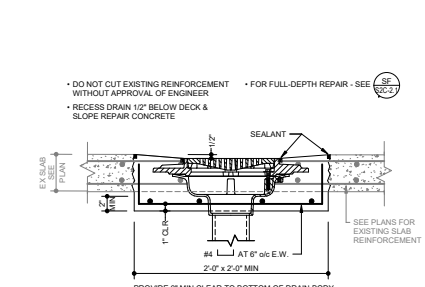
No.	Date	Revisions

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DRAWN: HR/JB/IRM
CHECKED: RM
APPROVED: FPM
Project No.: 18217
Date: 04/26/21
Scale: 1 1/2" = 1'-0"
Sheet Title: CONCRETE REPAIR DETAILS


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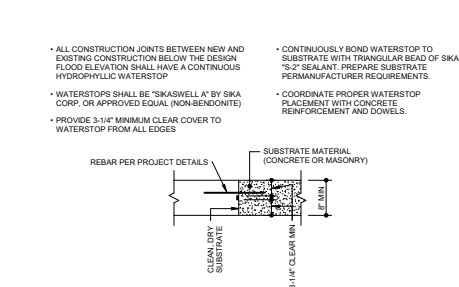
DD1 PROMENADE DECK DRAIN
1 1/2" = 1'-0"




DD2 PARKING DECK DRAIN
1 1/2" = 1'-0"




DD3 PLANTER DRAIN
1 1/2" = 1'-0"

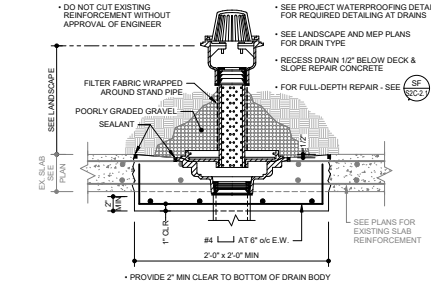

WS WATERSTOP
1" = 1'-0"

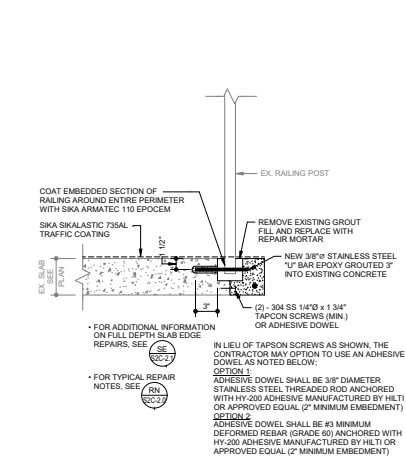


1 RAILING CONNECTION CONCRETE SPALL REPAIR
1 1/2" = 1'-0"

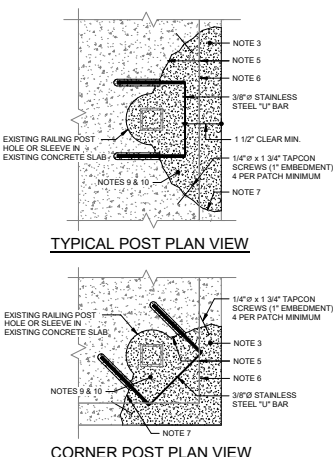


TYPICAL POST PLAN VIEW

CORNER POST PLAN VIEW

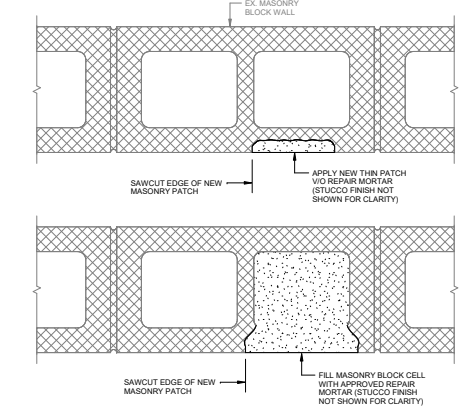


2 PARTIAL DEPTH MASONRY WALL REPAIR
3/4" = 1'-0"

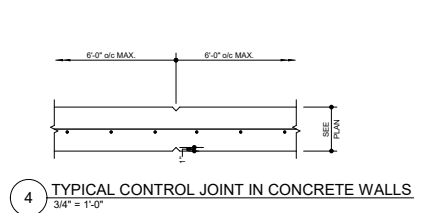


4 TYPICAL CONTROL JOINT IN CONCRETE WALLS
3/4" = 1'-0"

- TUCK-POINTING MASONRY NOTES:**
- REMOVE ALL LOOSE AND CRACKED MORTAR WITH CHISELS, GRINDING WHEELS, AND/OR OTHER APPROPRIATE EQUIPMENT DOWN TO A MINIMUM DEPTH OF 1/2". THE REPAIRED JOINTS SHALL BE CLEANED WITH A STIFF BRUSH ALONG WITH A LIGHT HOSE STREAM.
 - THE REPAIR MORTAR SHALL BE TYPE N PRE-HYDRATED TO REDUCE EXCESSIVE SHRINKAGE. THE PROPER PRE-HYDRATION PROCESS IS AS FOLLOWS:
 - ALL DRY INGREDIENTS SHALL BE THOROUGHLY MIXED PRIOR TO ADDITION OF WATER.
 - ONLY ENOUGH CLEAN WATER SHALL BE ADDED TO THE DRY MIX TO PRODUCE A DAMP, WORKABLE CONSISTENCY WHICH WILL RETAIN ITS SHAPE WHEN FORMED INTO A BALL.
 - THE MORTAR SHALL STAND IN THIS DAMPENED CONDITION FOR 1 TO 1 1/2 HOURS.
 - THE JOINTS TO BE TUCK-POINTED SHALL BE DAMPENED TO A SATURATED SURFACE DRY CONDITION, TO ENSURE A GOOD BOND. THE BRICKWORK MUST ABSORB ALL SURFACE WATER.
 - WATER SHOULD BE ADDED TO THE PRE-HYDRATED MORTAR TO BRING IT TO A WORKABLE CONSISTENCY (SOMEWHAT DRIER THAN CONVENTIONAL MORTAR).
 - THE MORTAR SHALL BE PACKED TIGHTLY INTO THE JOINTS IN THIN LAYERS (1/4" MAXIMUM). EACH LAYER SHALL BECOME "THUMBPRINT" HARD BEFORE APPLYING THE NEXT LAYER.
 - THE JOINTS SHALL BE TOOLED TO A CONCAVE PROFILE AFTER THE LAST LAYER OF MORTAR IS "THUMBPRINT" HARD.

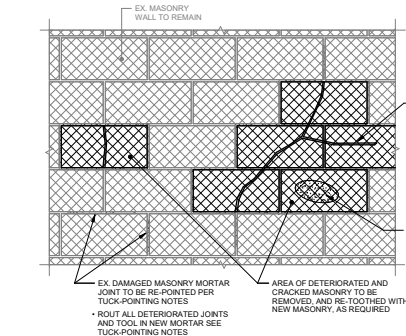

3 EXISTING MASONRY BLOCK REPAIRS
3/4" = 1'-0"

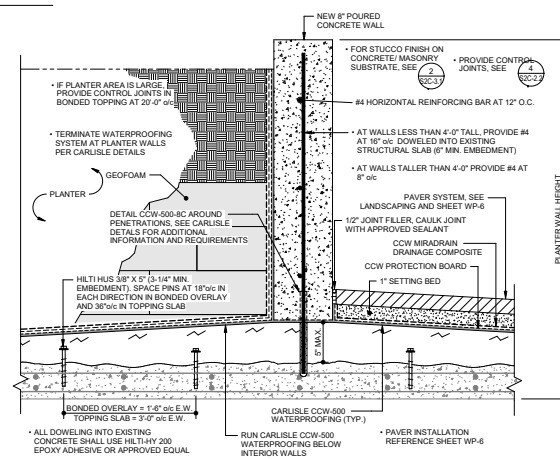

5 BONDED OVERLAY / TOPPING SLAB AT NEW POURED PLANTER WALL
1 1/2" = 1'-0"

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REPAIR & RESTORATION
PHASE IIC: OVERALL BUILDING
REPAIR AND RESTORATION

SCALE: License: 96025
Expirs: 08/2023




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No.	Date	Revisions

DESIGNED: HR/JB/IRM DRAWN: HR/JB/IRM
 CHECKED: RM APPROVED: FPM
 Project No.: 18217
 Date: 04/26/21
 Scale: As indicated
 Sheet Title:
CONCRETE MASONRY REPAIR DETAILS



Sheet No.:
S2C-2.2



1A BONDED OVERLAY / TOPPING SLAB AT EXISTING PLANTER WALL
NOT TO SCALE

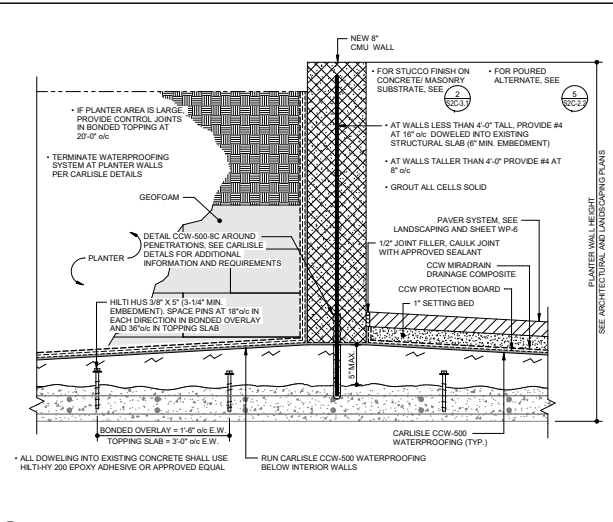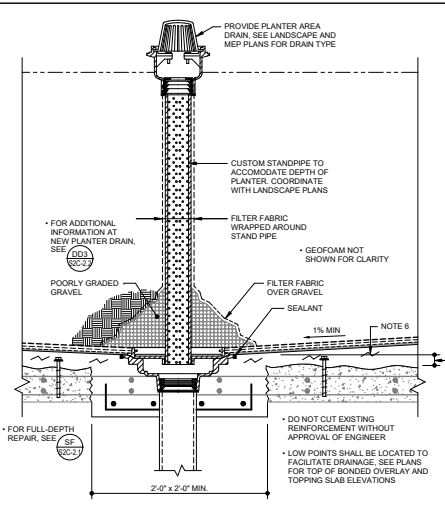
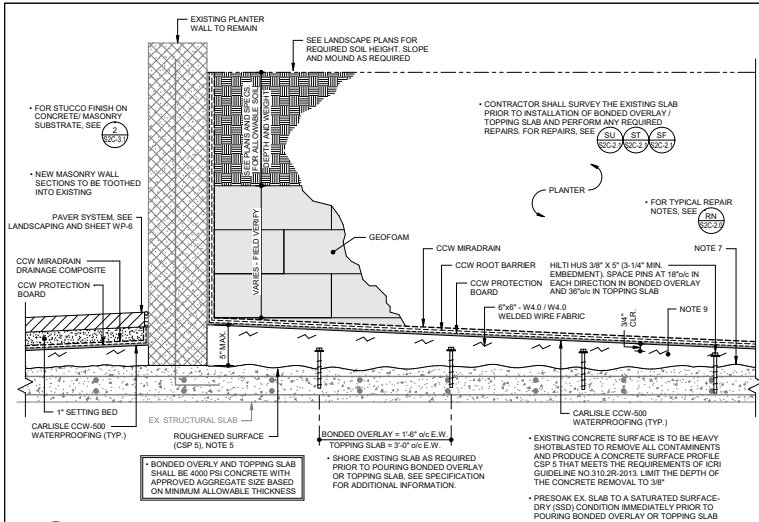
1B BONDED OVERLAY / TOPPING SLAB AT PLANTER DRAIN
NOT TO SCALE

1C BONDED OVERLAY / TOPPING SLAB AT NEW CMU PLANTER WALL
NOT TO SCALE

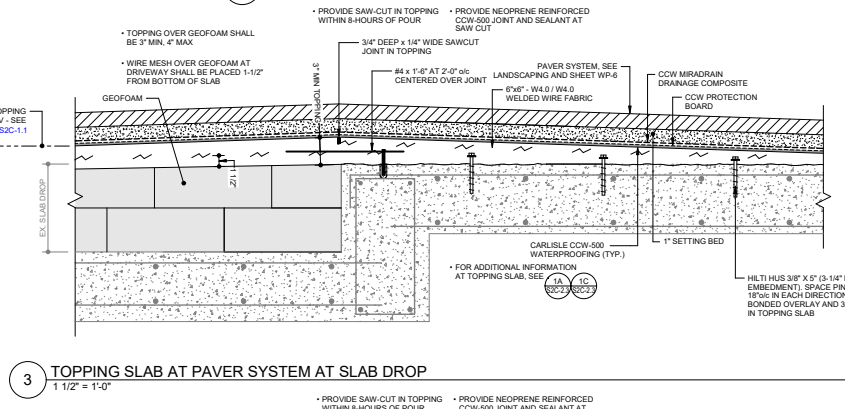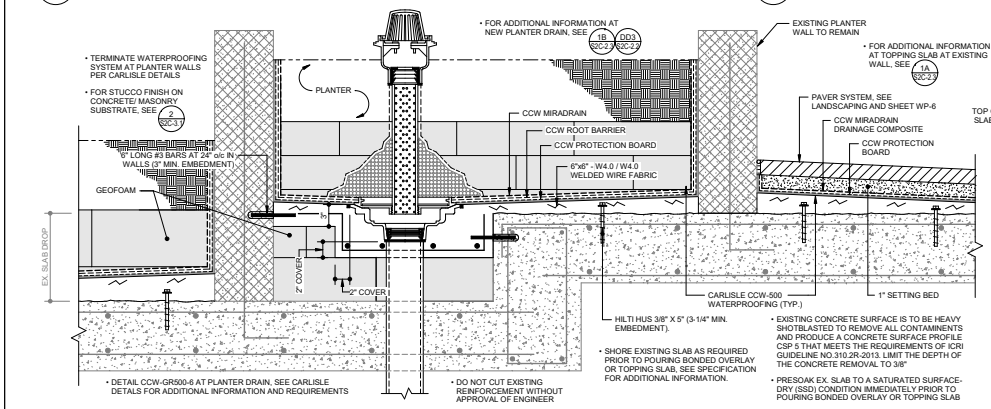

2 TOPPING SLAB & PAVER SYSTEM AT EXISTING PLANTER WALL AT SLAB DROP
1 1/2" = 1'-0"

3 TOPPING SLAB AT PAVER SYSTEM AT SLAB DROP
1 1/2" = 1'-0"

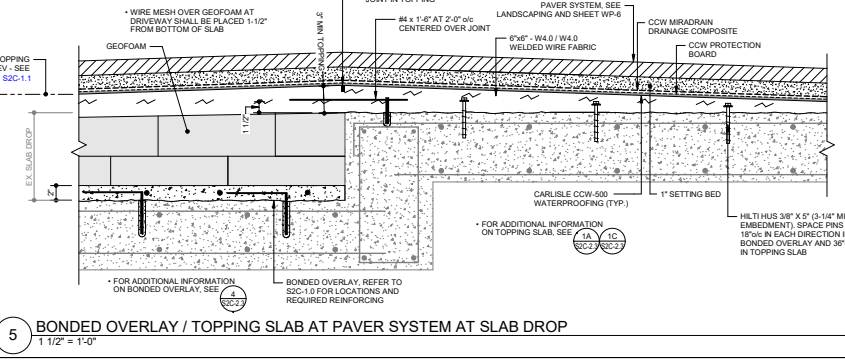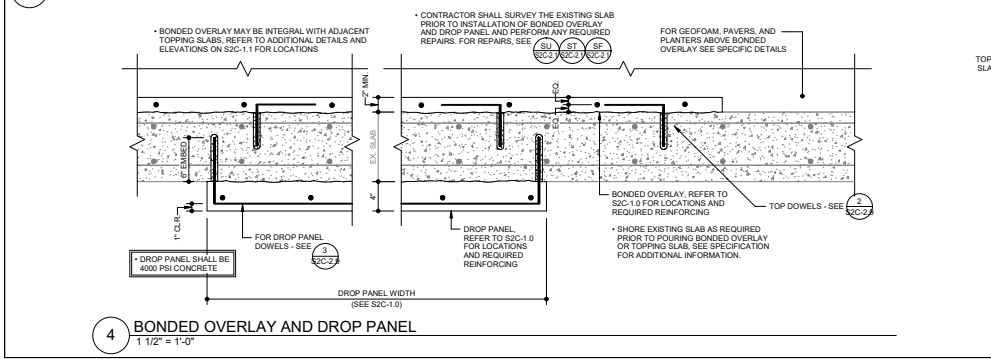

4 BONDED OVERLAY AND DROP PANEL
1 1/2" = 1'-0"

5 BONDED OVERLAY / TOPPING SLAB AT PAVER SYSTEM AT SLAB DROP
1 1/2" = 1'-0"

CHAMPLAIN TOWERS SOUTH CONDOMINIUM
8777 COLLINS AVENUE
SURFSIDE, FLORIDA 33154




CHAMPLAIN TOWERS SOUTH 40-YEAR BUILDING
REPAIR & RESTORATION
PHASE 1C: OVERALL BUILDING
REPAIR AND RESTORATION

SCALE: License 9802
Expiry: 09/2023
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DESIGNED	HR/JB/RM	DRAWN HR/JB/RM
CHECKED	RM	APPROVED FPM
Project No.:	18217	
Date:	04/26/21	
Scale:	1 1/2" = 1'-0"	
Sheet Title:	PLAZA DETAILS	
Sheet No.:	S2C-2.3	

No.	Date	Revisions


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CHECKED RM	APPROVED FPM
Project No.: 18217	
Date: 04/26/21	
Scale: 1 1/2" = 1'-0"	
Sheet Title: PLAZA DETAILS	

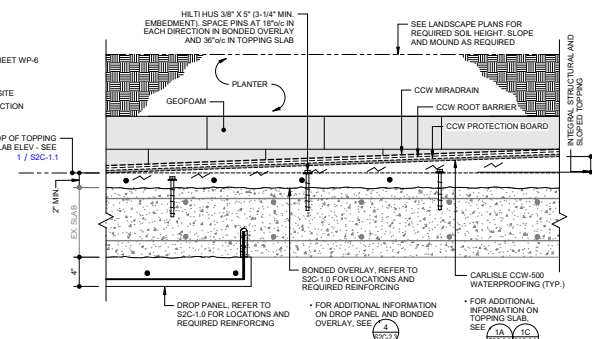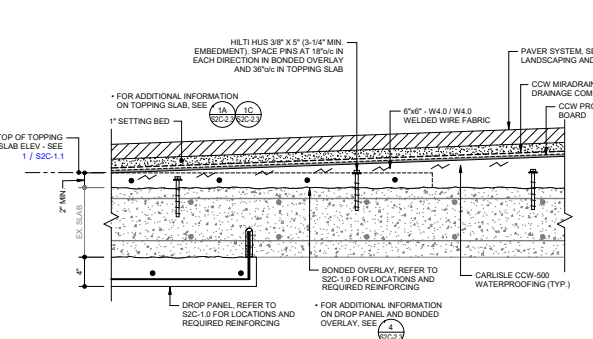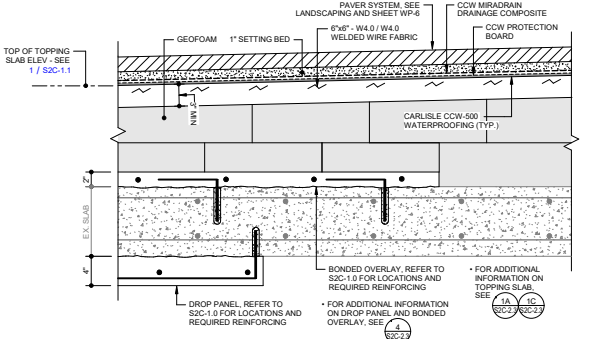


1 BONDED OVERLAY / TOPPING SLAB AT RAISED PAVERS
1 1/2" = 1'-0"

2 INTEGRAL BONDED OVERLAY / TOPPING SLAB AT PAVERS
1 1/2" = 1'-0"


3 INTEGRAL BONDED OVERLAY / TOPPING SLAB AT PLANTER
1 1/2" = 1'-0"

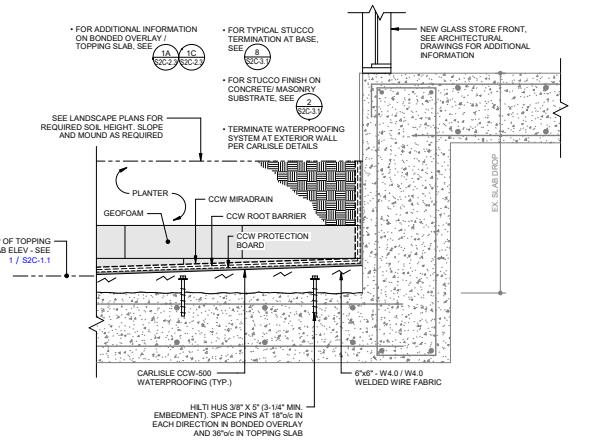


4 TOPPING SLAB AND PLANTER AT STORE FRONT AT SLAB DROP
1 1/2" = 1'-0"

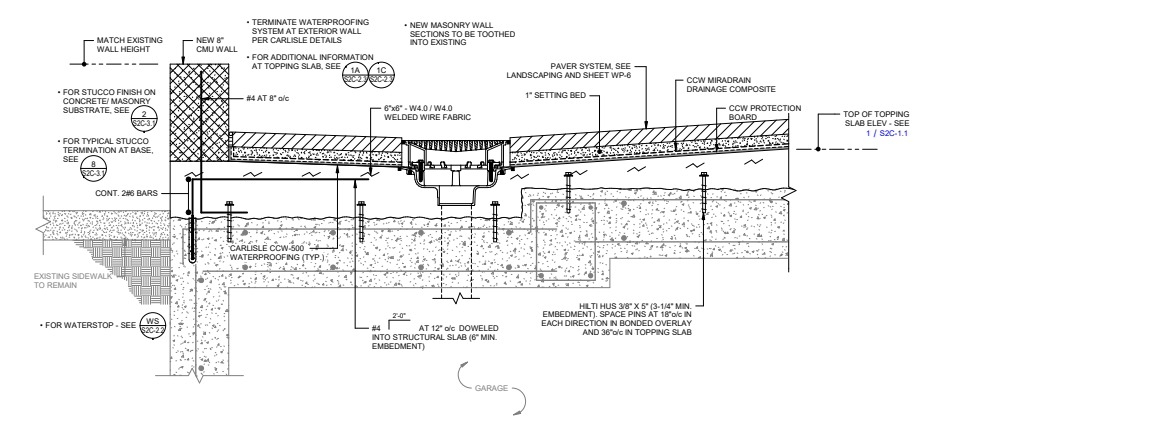

6 TOPPING SLAB AT NEW EXTERIOR CMU WALL
1 1/2" = 1'-0"

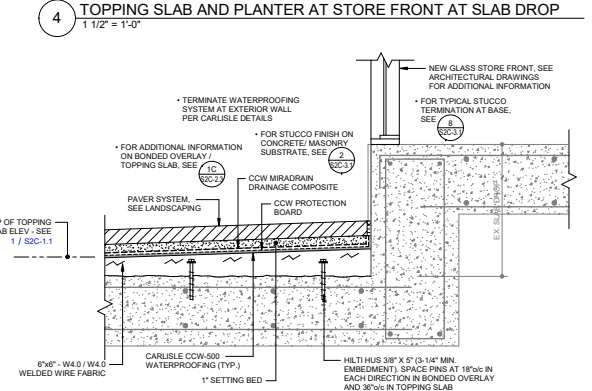


5 TOPPING SLAB AND PAVERS AT STORE FRONT AT SLAB DROP
1 1/2" = 1'-0"

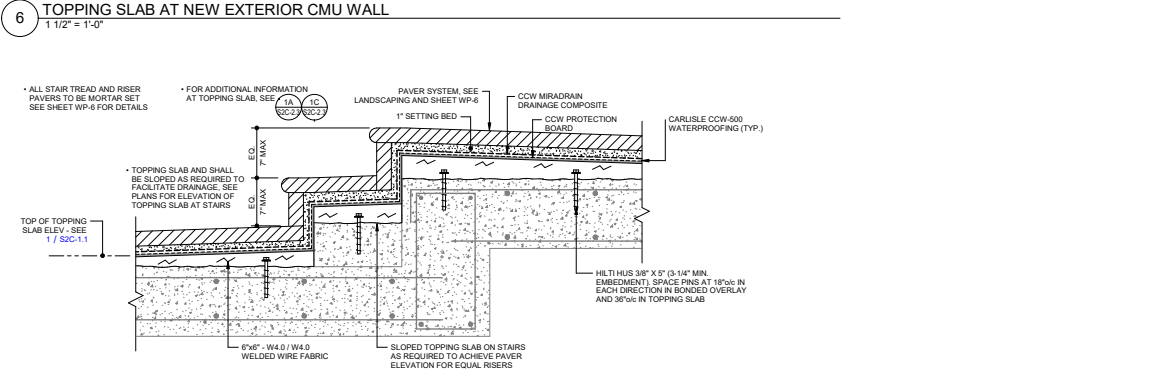


7 TOPPING SLAB AND PAVERS AT EXISTING STAIRS AT SLAB DROP
1 1/2" = 1'-0"


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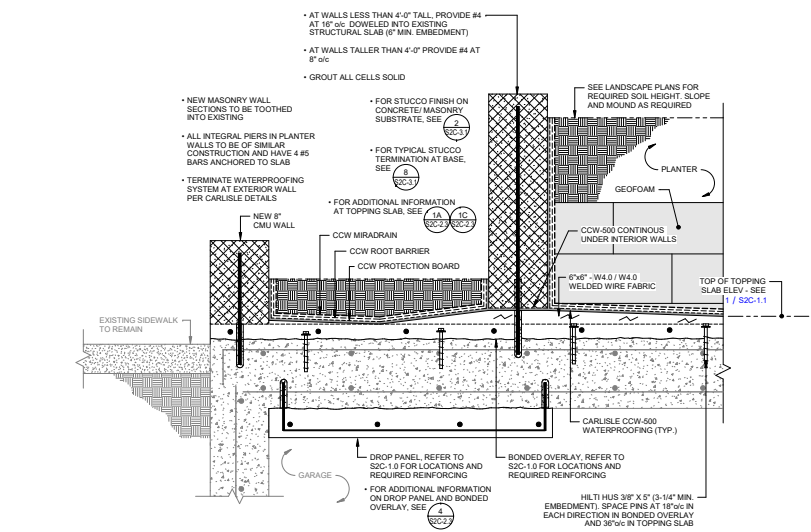
1 DRAIN IN TOPPING SLAB AT RAISED PAVER SYSTEM AT SLAB DROP
1 1/2" = 1'-0"

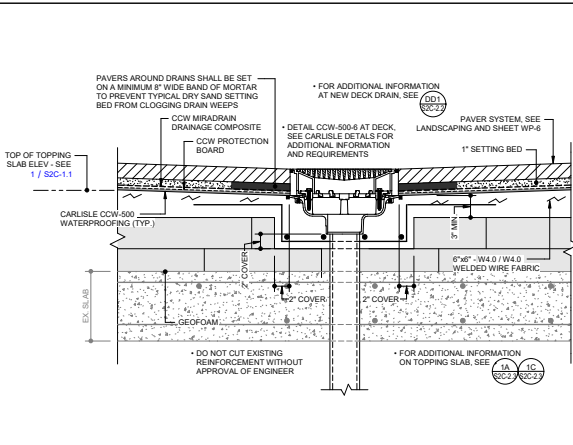


2 DRAIN IN TOPPING SLAB AT PAVER SYSTEM (TYPICAL)
1 1/2" = 1'-0"

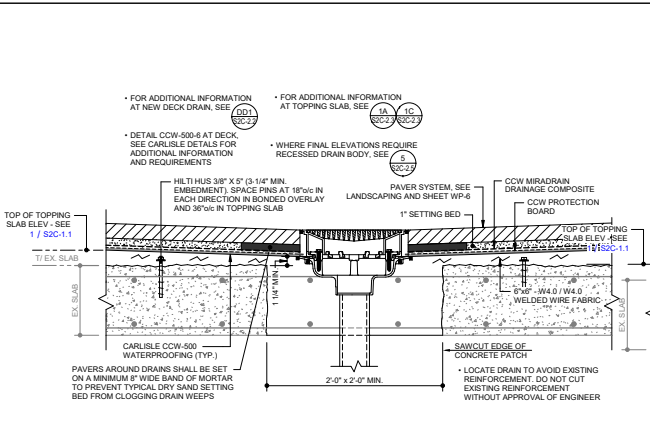


3 DRAIN IN TOPPING SLAB AT PLANTERS
1 1/2" = 1'-0"

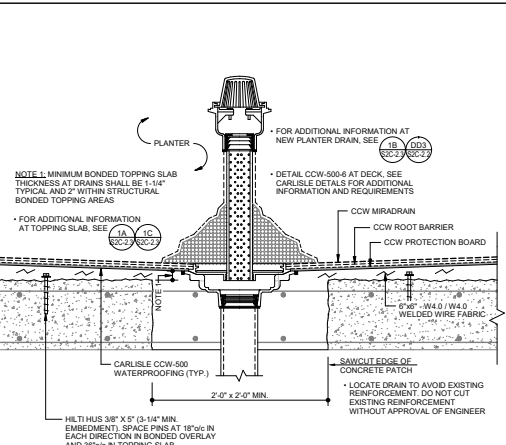

4 BONDED OVERLAY / TOPPING SLAB AT NEW EXTERIOR & INTERIOR CMU WALLS
1 1/2" = 1'-0"

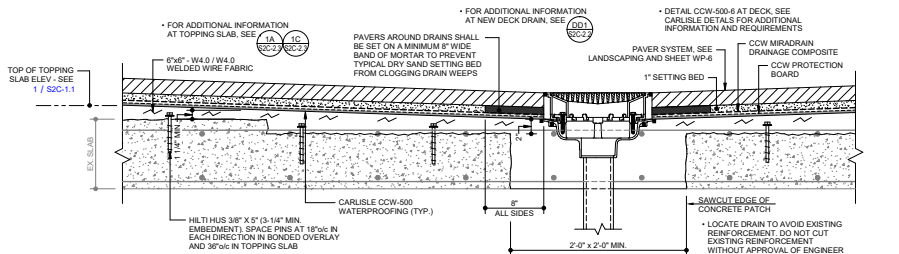

5 DRAIN IN TOPPING SLAB AT PAVER SYSTEM (ALTERNATE)
1 1/2" = 1'-0"

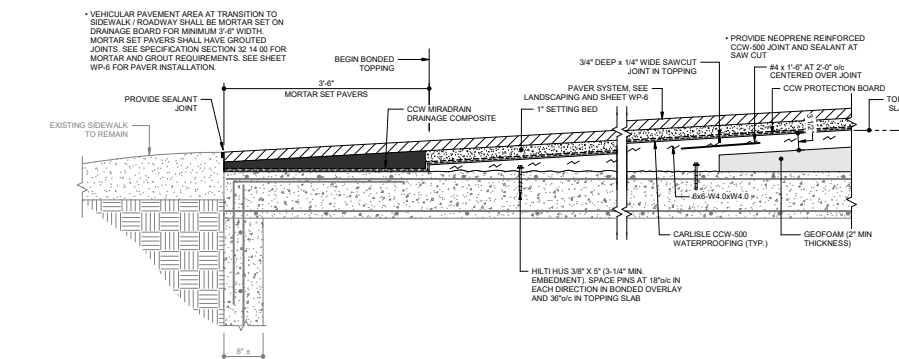

6 EXISTING DRIVEWAY RAMP AT FOUNDATION
1" = 1'-0"

No.	Date	Revisions


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CHECKED:	RM	APPROVED:	FPM
Project No.:	18217	Date:	04/26/21
Scale:	As indicated	Sheet Title:	PLAZA DETAILS

No.	Date	Revisions


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APPROVED: FPM

Project No.: 18217
Date: 04/26/21
Scale: As indicated
Sheet Title: PLAZA DETAILS


Sheet No.:
S2C-2.6

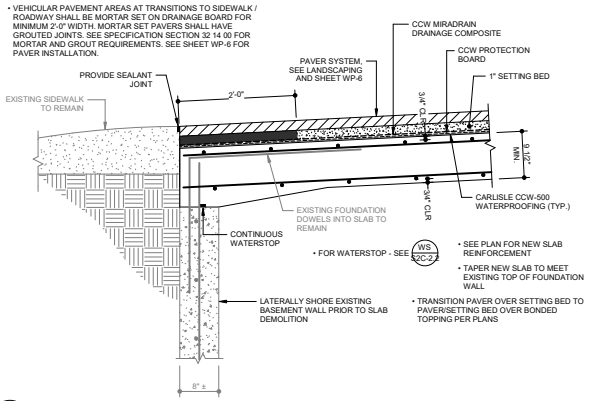


1 NEW DRIVEWAY RAMP AT FOUNDATION
1" = 1'-0"

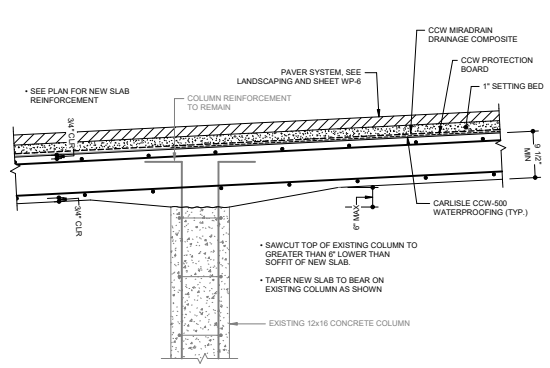


2 RAMP SLAB AT EXISTING COLUMN
1" = 1'-0"

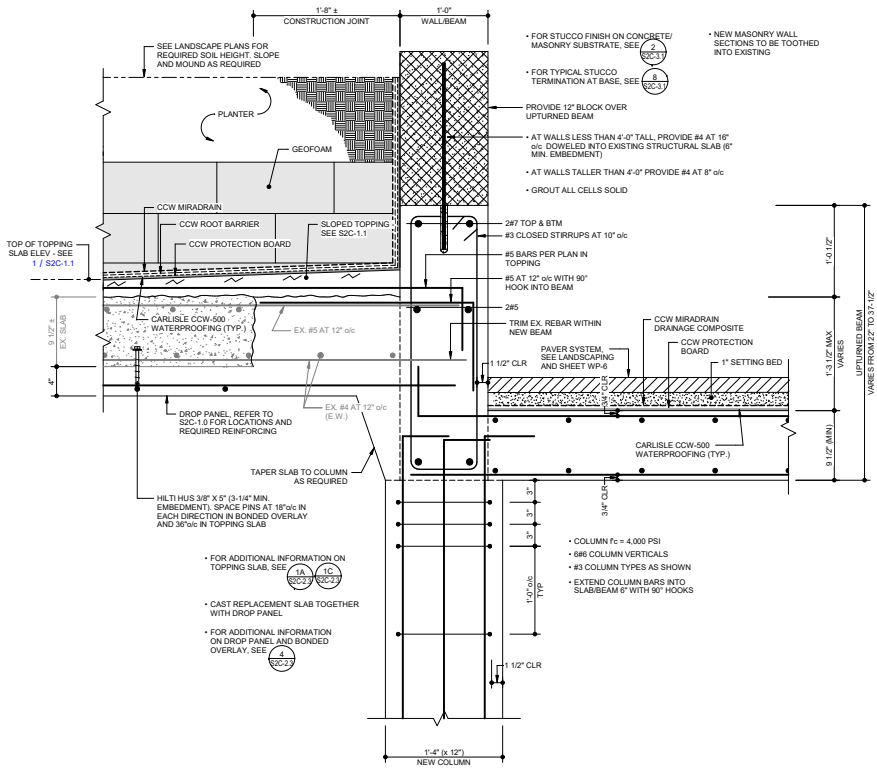


3 NEW UPTURN BEAM AT ENTRANCE RAMP
1 1/2" = 1'-0"

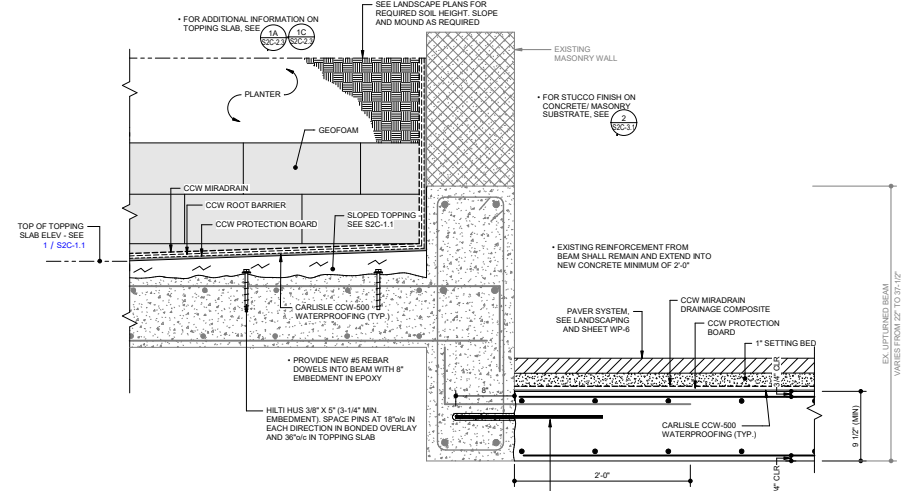


4 EXISTING UPTURN BEAM AT ENTRANCE RAMP
1 1/2" = 1'-0"

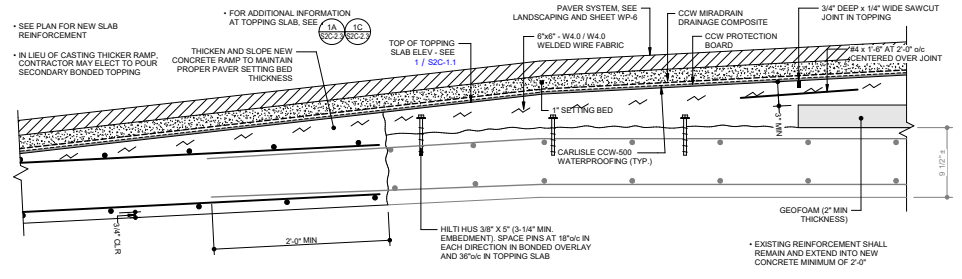


5 TOPPING SLAB RAMP TRANSITION
1 1/2" = 1'-0"

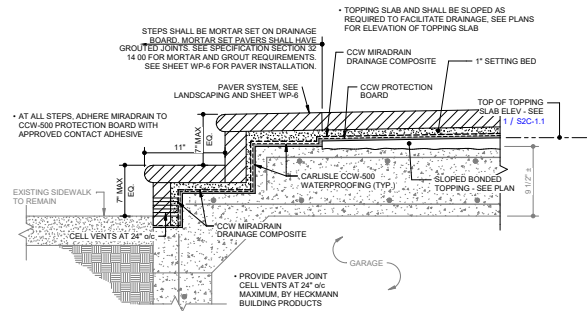


1 EXISTING STEPS AT FOUNDATION WALL
1 1/2" = 1'-0"

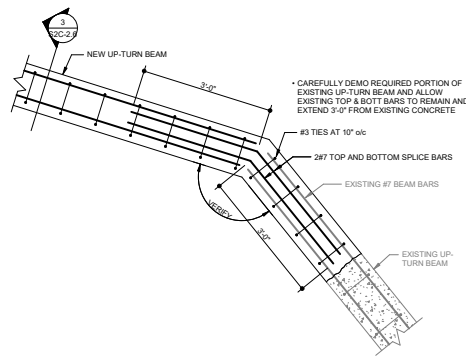


2 CONCRETE BEAM TIE-IN TO EXISTING BEAM
3/4" = 1'-0"

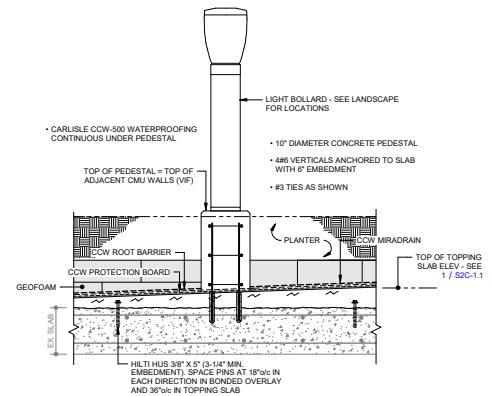

3 TYPICAL PLANTER BOLLARD
1" = 1'-0"

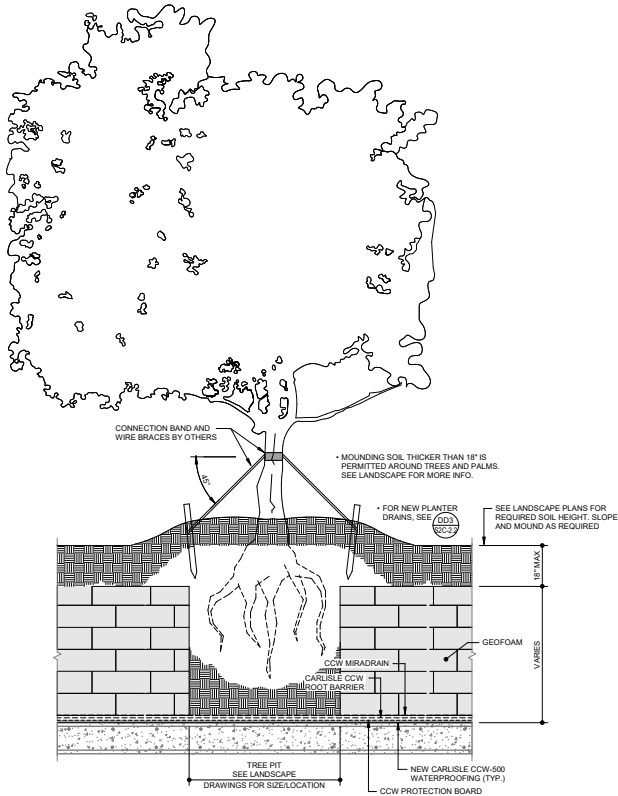

4 TYPICAL LARGE TREE PIT
NOT TO SCALE

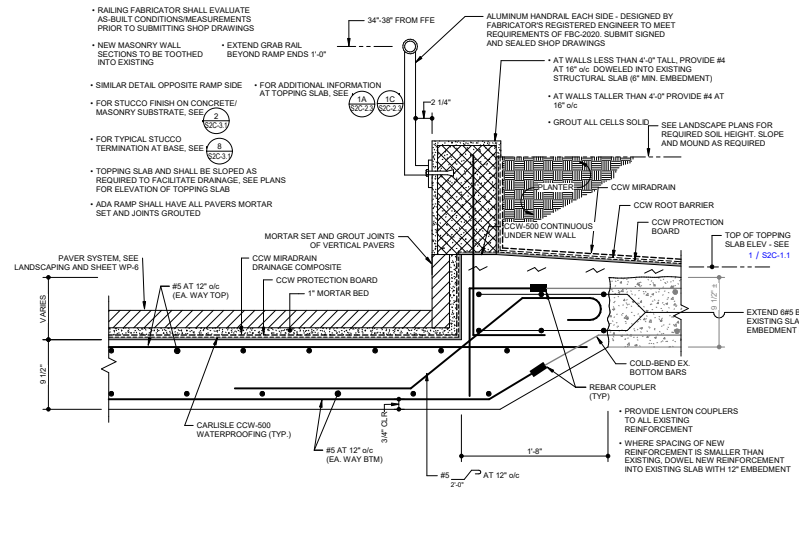

5 SECTION THRU ADA RAMP
1 1/2" = 1'-0"



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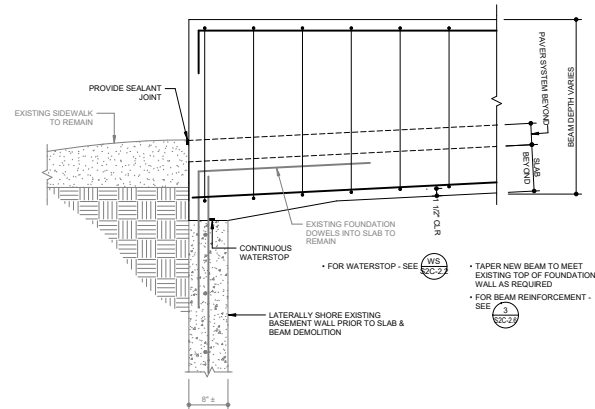
No.	Date	Revisions	
DESIGNED	HR/JB/RM	DRAWN	HR/JB/RM
CHECKED	RM	APPROVED	FPM
Project No.:	18217		
Date:	04/26/21		
Scale:	As indicated		
Sheet Title:	PLAZA DETAILS		

Sheet No.:
S2C-2.7




1 NEW AIR SHAFT WALLS
 1 1/2" = 1'-0"


3 ADA RAMP AT FOUNDATION
 1 1/2" = 1'-0"

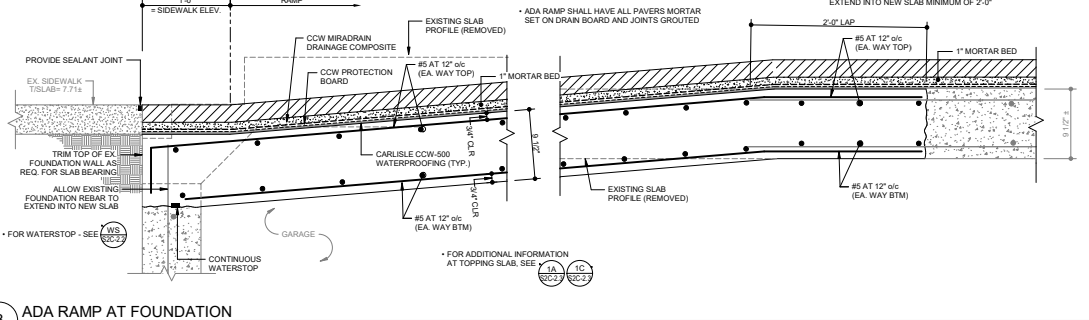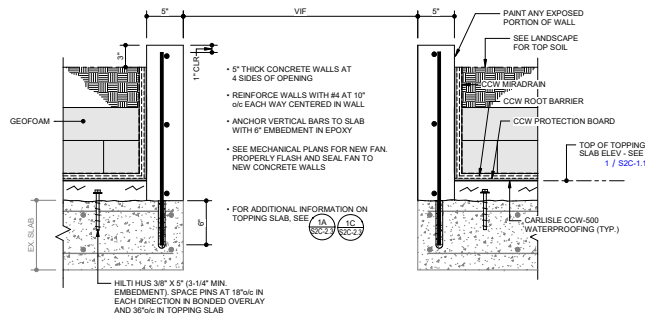


2 BASEMENT WALL AT NEW BEAM
 1" = 1'-0"

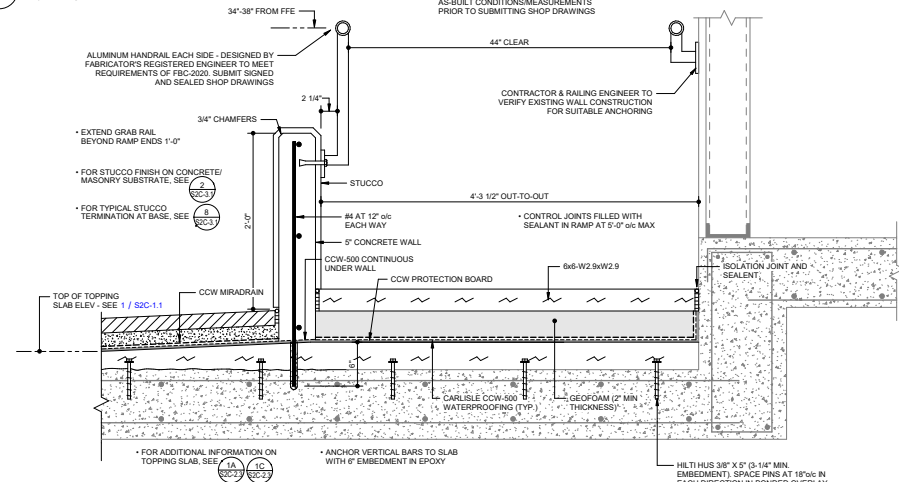

4 ADA RAMP AT ENTRANCE
 1 1/2" = 1'-0"

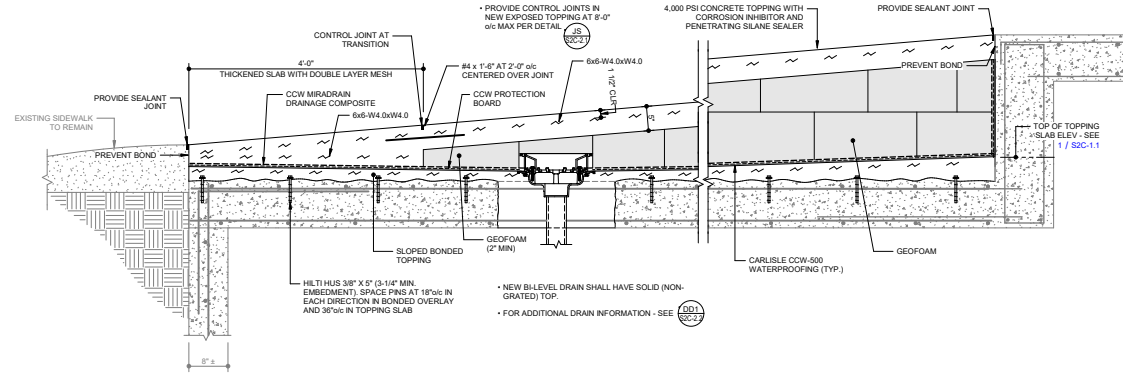

5 EXISTING SERVICE DRIVEWAY RAMP
 1" = 1'-0"

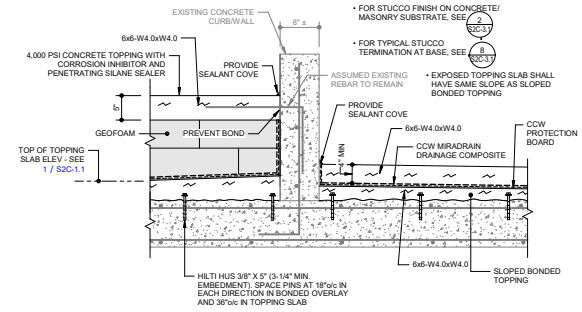

6 EXISTING SERVICE DRIVEWAY RAMP
 1" = 1'-0"

SCALE: License 96525
 Expires: 08/2023

No.	Date	Revisions

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Project No.: 18217
 Date: 04/26/21
 Scale: As indicated
 Sheet Title: PLAZA DETAILS

SCALE License: 9602
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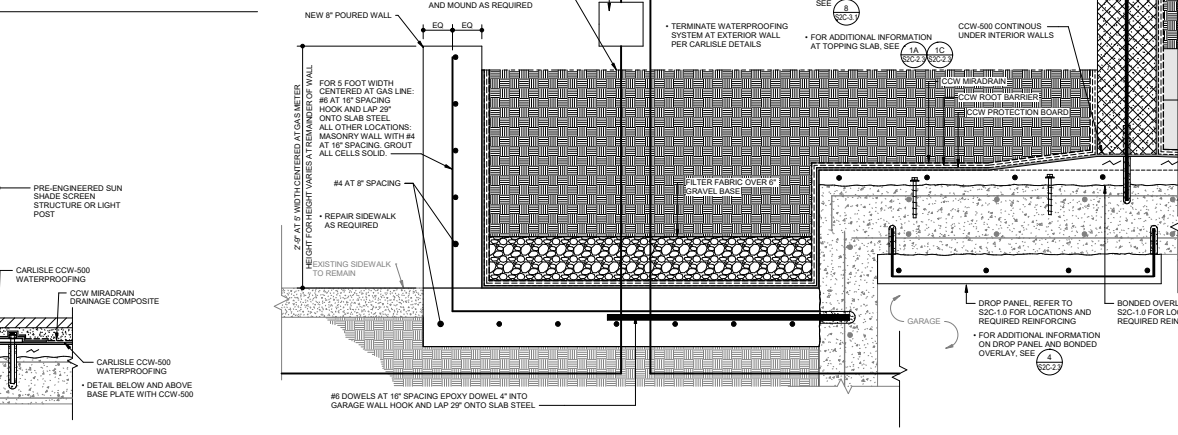
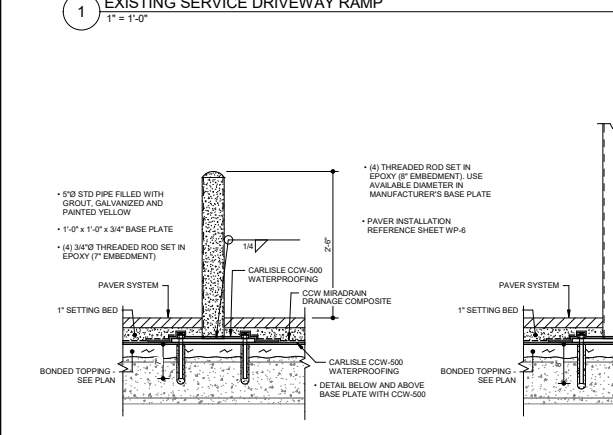
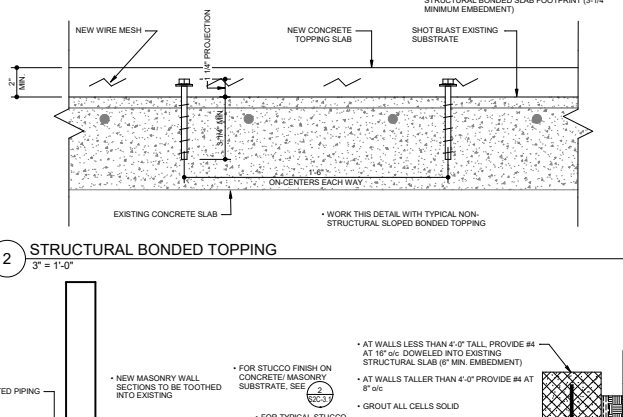
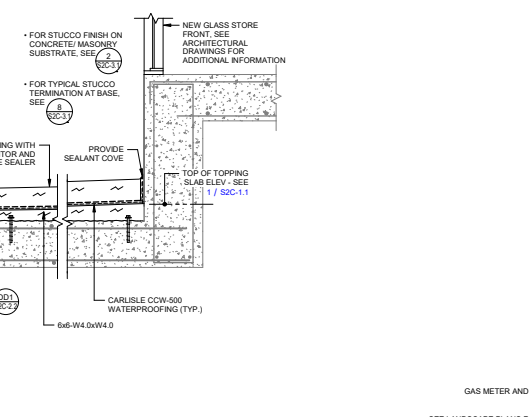
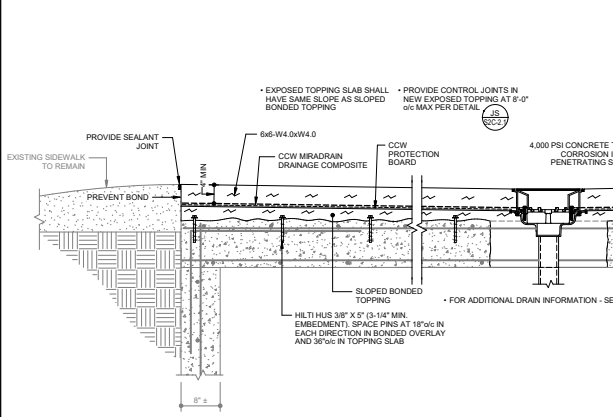
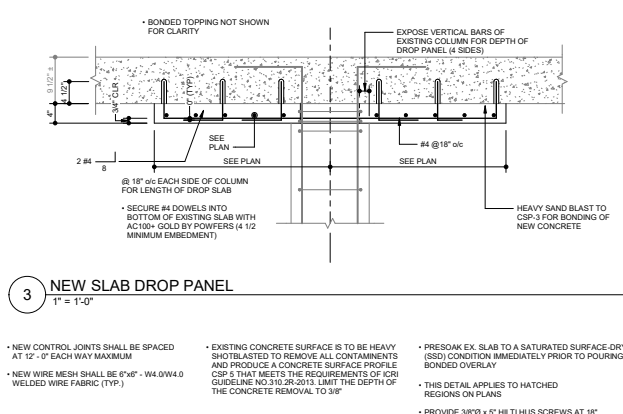
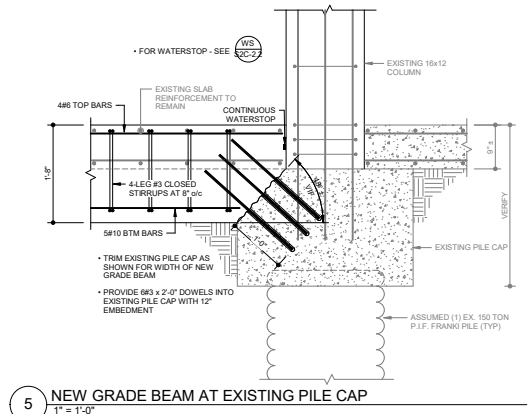
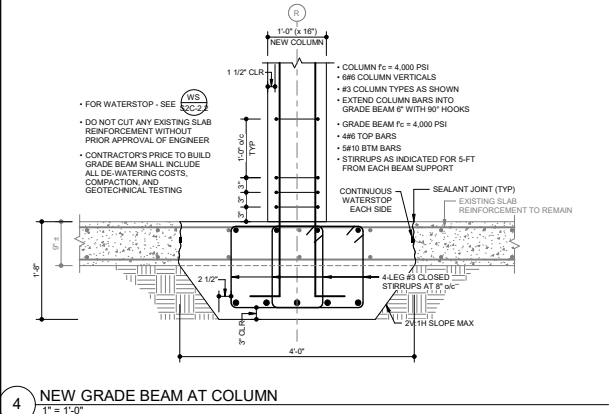
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No.	Date	Revisions

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Project No.: 18217
Date: 04/26/21
Scale: As indicated
Sheet Title: PLAZA & FOUNDATION DETAILS

Sheet No.: S2C-2.9



4 NEW GRADE BEAM AT COLUMN
1" = 1'-0"

5 NEW GRADE BEAM AT EXISTING PILE CAP
1" = 1'-0"


3 NEW SLAB DROP PANEL
1" = 1'-0"

1 EXISTING SERVICE DRIVEWAY RAMP
1" = 1'-0"


2 STRUCTURAL BONDED TOPPING
3" = 1'-0"

7 EXPANDED GAS LINE SLAB AND WALL EXTENSION
1 1/2" = 1'-0"


6 BOLLARD AND STRUCTURE SLAB ANCHORING
1" = 1'-0"

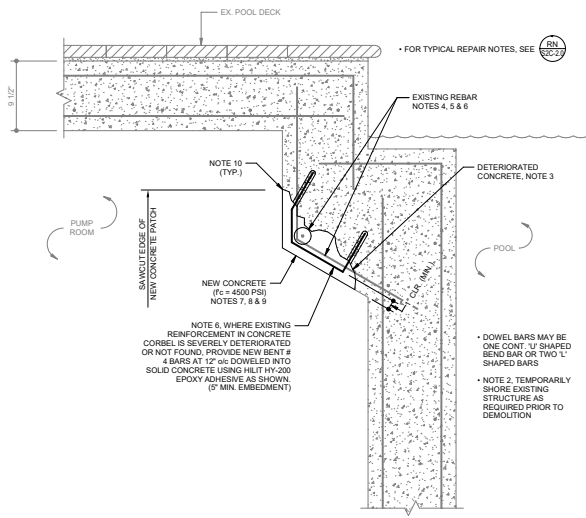


1 CONCRETE CORBEL REPAIR AT POOL
1 1/2" = 1'-0"

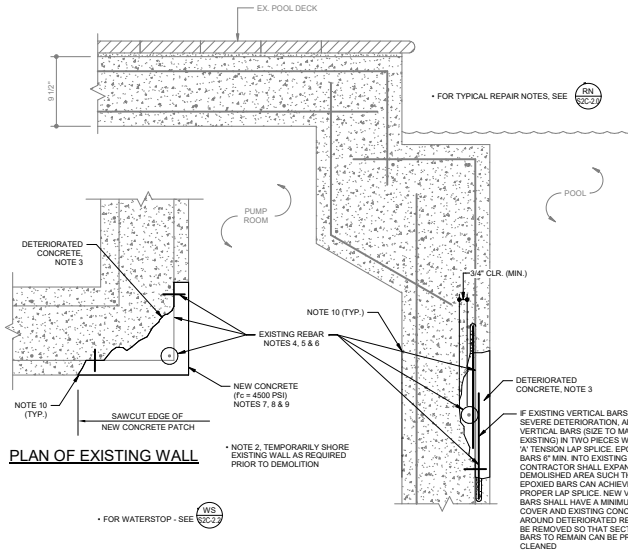


2 POOL WALLS CONCRETE SPALL REPAIR
1 1/2" = 1'-0"

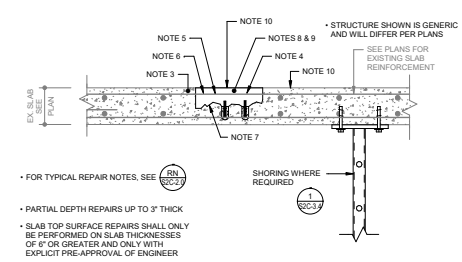


4 POOL SLAB TOP SURFACE REPAIR
1 1/2" = 1'-0"

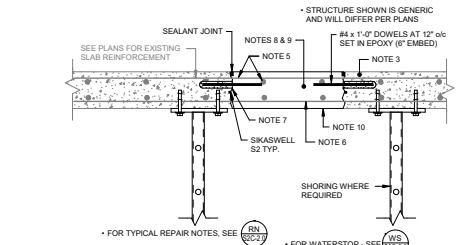

3 POOL SLAB FULL-DEPTH REPAIR
1 1/2" = 1'-0"

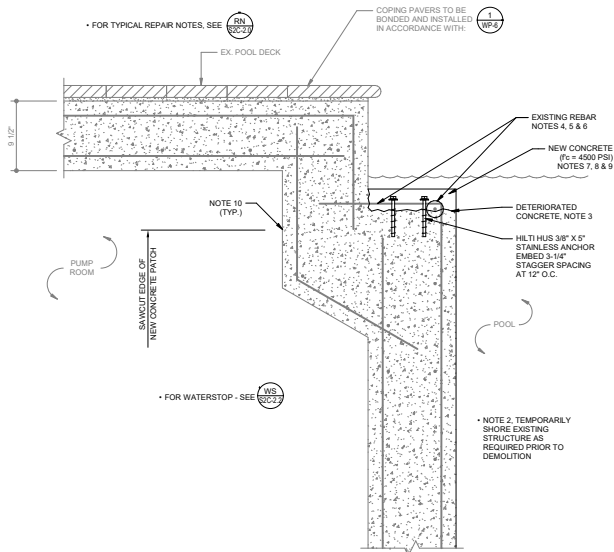

5 CONCRETE GUTTER REPAIR AT POOL
1 1/2" = 1'-0"

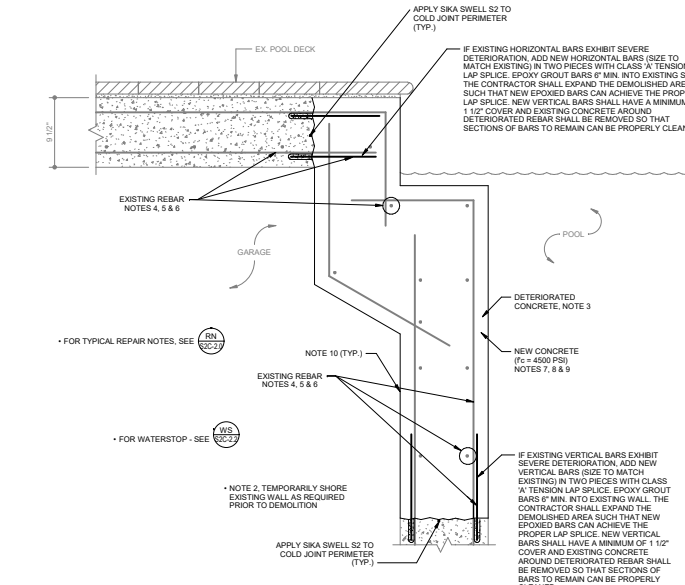

6 POOL WALLS CONCRETE FULL DEPTH REPAIR
1 1/2" = 1'-0"

CHAMPLAIN TOWERS
SOUTH CONDOMINIUM
8777 COLLINS AVENUE
SURFSIDE, FLORIDA 33164

CHAMPLAIN TOWERS SOUTH 40-YEAR BUILDING
REPAIR & RESTORATION
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No.	Date	Revisions

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Project No.:	18217		
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Sheet Title:	POOL REPAIR DETAILS		

Sheet No.:
S2C-3.0

SCALE: License: 96022
Expiry: 03/2023

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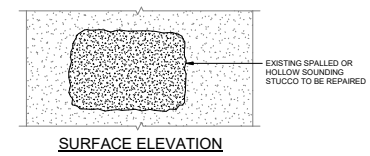
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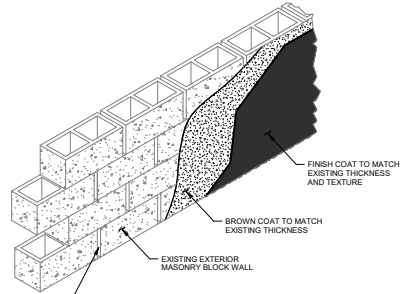
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Project No.: 18217
Date: 04/26/21
Scale: 3/4" = 1'-0"
Sheet Title: STUCCO REPAIR DETAILS

Sheet No.:
S2C-3.1




- SURFACE ELEVATION**
- PRIOR TO COMMENCEMENT OF STUCCO REPAIRS, THE CONTRACTOR SHALL HIRE AN EXPERIENCED TESTING LABORATORY TO COMPLETE A CHEMICAL AND MICROSCOPIC ANALYSIS OF THE EXISTING STUCCO.
 - CHIP-OFF ALL DELAMINATED STUCCO WITH CHISEL AND HAMMER.
 - PROPERLY CLEAN EXISTING SURFACE TO RECEIVE STUCCO REPAIR.
 - MECHANICALLY ROUGHEN EXISTING BROWN COAT SURFACE WITH SAND BLASTING OR LIGHT CHIPPING HAMMER OR HAMMER AND CHISEL TO REMOVE LOOSE MATERIAL. TO ASSURE PROPER BONDING, SURFACE MUST BE STRUCTURALLY SOUND AND CLEAN, FREE OF ANY AND ALL OIL, GREASE, WAX, DUST, SAND, DIRT, LANTHANE, PAINT, EFFLORESCENCE, CURING COMPOUNDS, FORM RELEASE AGENTS AND BASE MATERIALS OF ANY KIND.
 - COAT PREPARED SURFACE WITH AN APPROVED BONDING AGENT CONFORMING TO ASTM C-932.
 - STUCCO REPAIR MATERIALS SHALL MATCH THE EXISTING STUCCO AS DETERMINED BY THE LABORATORY ANALYSIS. SUBMIT PRODUCT DATA FOR APPROVAL.
 - TOUCH-UP BROWN COAT AND INSTALL NEW FINISH COAT OF STUCCO TO MATCH EXISTING IN COLOR, THICKNESS AND APPEARANCE. SEE SPECIFICATIONS FOR ADDITIONAL PROJECT REQUIREMENTS.




2 NEW STUCCO OVER MASONRY / CONCRETE SURFACES
3/4" = 1'-0"


3 STUCCO REPAIR OVER MASONRY / CONCRETE SURFACES
3/4" = 1'-0"

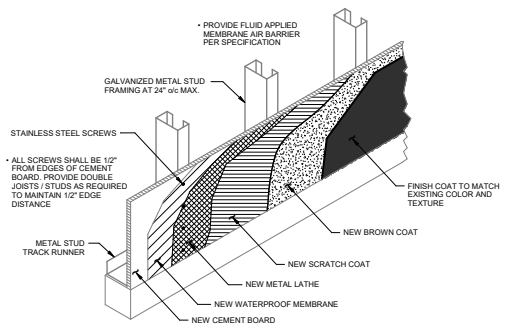


1 NEW STUCCO OVER LIGHTGAGE / CEMENT BOARD SURFACES
3/4" = 1'-0"

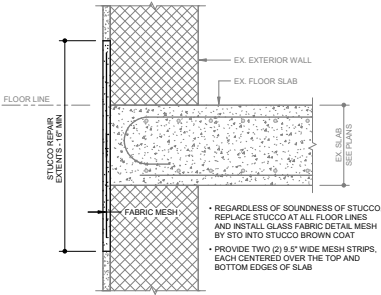


6 STUCCO REINFORCEMENT AT FLOOR LINES
3/4" = 1'-0"

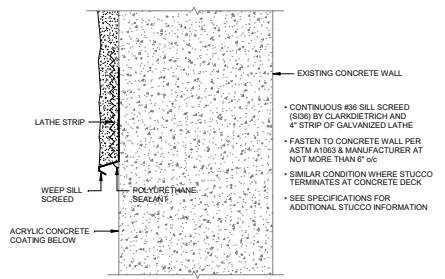


8 STUCCO WEEP SCREEN AT BASE/FOUNDATION
3/4" = 1'-0"

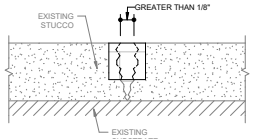

4 REPAIR OF STUCCO CRACKS GREATER THAN 1/8" WIDE
3/4" = 1'-0"

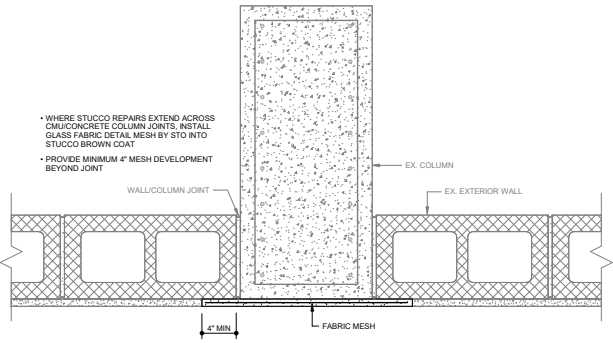

7 STUCCO REINFORCEMENT AT WALL AND COLUMN JOINTS
3/4" = 1'-0"

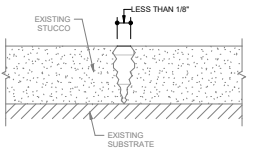

5 REPAIR OF STUCCO CRACKS LESS THAN 1/8" WIDE
3/4" = 1'-0"


- CRACKS TO BE REPAIRED SHALL BE ROUTED TO A MINIMUM WIDTH AND DEPTH OF 1/4" TO ACCOMMODATE STUCCO FILL. THE EDGES OF THE CRACK SHALL BE UNDERCUT WHERE POSSIBLE. BRUSH CRACKS CLEAN OF LOOSE DEBRIS WITH A SOFT BRUSH.
- THE AREA TO RECEIVE THE STUCCO FILL SHALL BE THOROUGHLY WETTED TO PREVENT DEHYDRATION OF THE STUCCO. RE-WET AS NECESSARY.
- USING THE APPROVED STUCCO MIX, FILL THE CRACK AND WORK STUCCO IN AS TIGHTLY AS POSSIBLE UNTIL FLUSH WITH ADJOINING SURFACE. REMOVE EXCESS STUCCO.
- PROTECT FILLED AREAS WITH PLASTIC SHEETING AND RE-WET PERIODICALLY TO ALLOW A FULL CURE.

- REGARDLESS OF SOUNDNESS OF STUCCO, REPLACE STUCCO AT ALL FLOOR LINES AND INSTALL GLASS FABRIC DETAIL MESH BY STO INTO STUCCO BROWN COAT.
- PROVIDE TWO (2) 9.5" WIDE MESH STRIPS, EACH CENTERED OVER THE TOP AND BOTTOM EDGES OF SLAB.


- CONTINUOUS #8 SILL SCREEN (SIS8) BY CLARKDIETRICH AND 4" STRIP OF GALVANIZED LATH.
- FASTEN TO CONCRETE WALL PER ASTM A1063 & MANUFACTURER AT NOT MORE THAN 6" OC.
- SIMILAR CONDITION WHERE STUCCO TERMINATES AT CONCRETE DECK.
- SEE SPECIFICATIONS FOR ADDITIONAL STUCCO INFORMATION.

- CRACK SHOULD BE FREE FROM DIRT, GREASE, AND VEGETATION. BLOW CRACKS CLEAN WITH COMPRESSED AIR, NOT TO EXCEED 150 PSI.
- COAT CRACK WITH A BONDING AGENT CONFORMING TO ASTM C-932 IN ACCORDANCE WITH MANUFACTURER'S INSTRUCTIONS.
- PREPARE A SLURRY COAT OF STUCCO TO MATCH THE COLOR AND FINISH OF THE EXISTING STUCCO. APPLY A LIGHT COAT OF THE SLURRY ALONG THE CRACK AND WORK TO MATCH EXISTING STUCCO.


- WHERE STUCCO REPAIRS EXTEND ACROSS CMU/CONCRETE COLUMN JOINTS, INSTALL GLASS FABRIC DETAIL MESH BY STO INTO STUCCO BROWN COAT.
- PROVIDE MINIMUM 4" MESH DEVELOPMENT BEYOND JOINT.

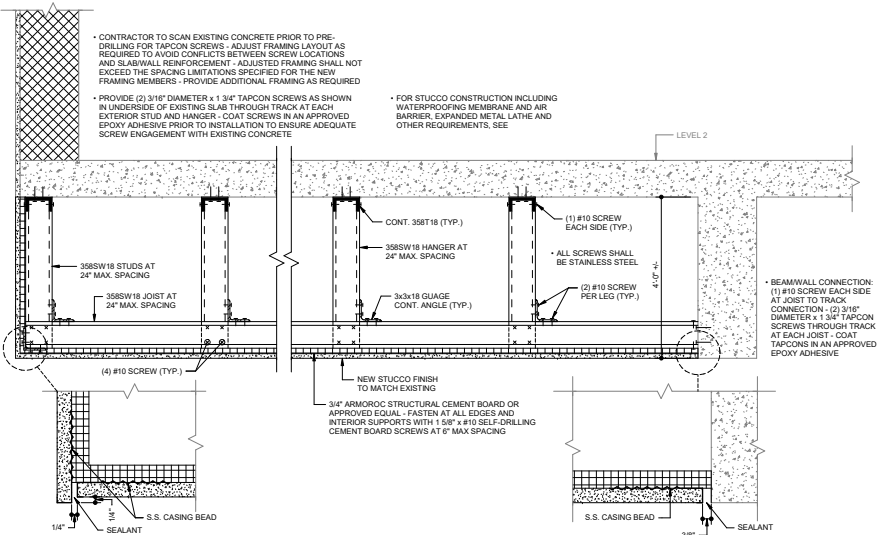


1 HUNG SOFFIT REPLACEMENT
1 1/2" = 1'-0"

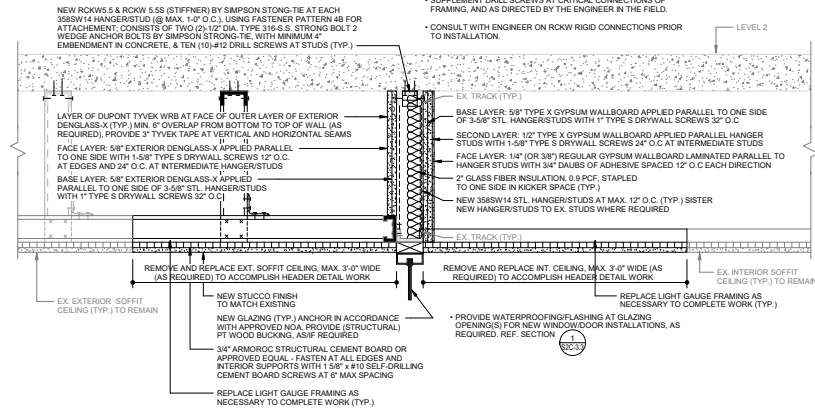

2 FIRST FLOOR COMMON AREA GLAZING HEADER REINFORCEMENT
1 1/2" = 1'-0"

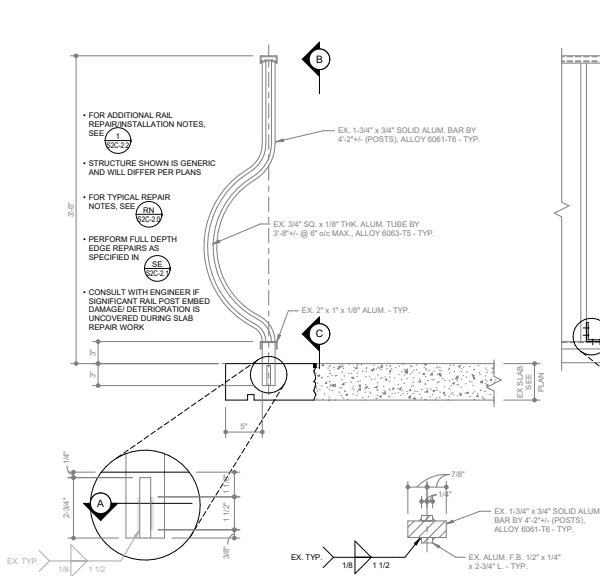


3 RAIL REPAIR
1 1/2" = 1'-0"

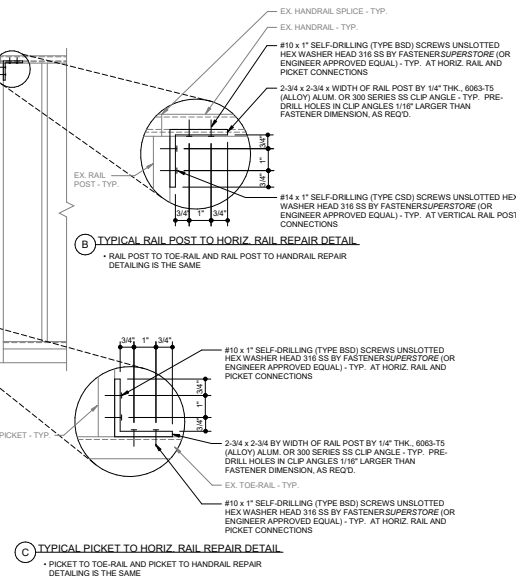



C TYPICAL PICKET TO HORIZ. RAIL REPAIR DETAIL
• PICKET TO TOE-RAIL AND PICKET TO HANDBAIL REPAIR DETAILING IS THE SAME

No.	Date	Revisions
DESIGNED	HR/JB/RM	DRAWN HR/JB/RM
CHECKED	RM	APPROVED FPM
Project No.:	18217	
Date:	04/26/21	
Scale:	1 1/2" = 1'-0"	
Sheet Title:	SOFFIT AND RAIL REPAIR DETAILS	

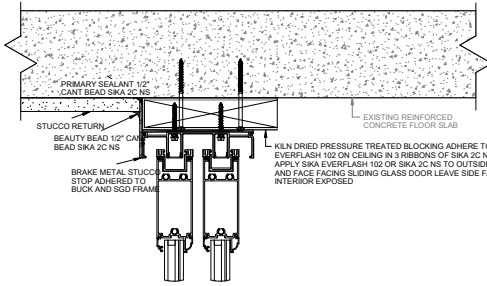



- GENERAL NOTES:**
1. SLIDING GLASS DOOR INSTALLATION TO BE IN ACCORDANCE WITH MIAMI-DADE NOA 20-0429-03
 2. IF BUCKING AT HEADER OR JAMB REQUIRES LESS THAN 2X, ATTACH BUCKING WITH MINIMAL NUMBER OF FASTENERS TO ENSURE TIGHT BOND TO CONCRETE SUBSTRATE. INSTALL REQUIRED NUMBER OF CONCRETE FASTENERS FOR SLIDING GLASS DOOR FRAME THROUGH BUCKING TO ACHIEVE MINIMUM EMBEDMENT INTO SUBSTRATE REQUIRED BY MIAMI-DADE NOA. EMBEDMENT DEPTH DOES NOT INCLUDE BUCKING.
 3. IF BUCKING AT HEADER OR JAMB IS EQUAL TO A 2X OR GREATER, ATTACH BUCKING (SEE FASTENING SCHEDULE THIS SHEET) USING 1/4\"/>

- SILL CONSTRUCTION GENERAL PROCEDURE:**
1. REMOVE AND DISPOSE EXISTING SLIDING GLASS DOOR, FRAME, AND BUCKING. REPAIR CONCRETE IF NECESSARY. PREPARE FLOOR SLAB TO ICRI CSP-7.
 2. REMOVE ALL DUST AND DEBRIS. WET PREPARED FLOOR SLAB TO SSD CONDITION.
 3. MIX SIKAGUICK 1000 IN ACCORDANCE WITH MANUFACTURER'S GUIDELINES. APPLY BONDOCOAT OF SIKAGUICK 1000 TO PREPARED SSD FLOOR SLAB USING STIFF BRISTLE IMMEDIATELY POUR GROUT BED LEVEL. 1/2\"/>

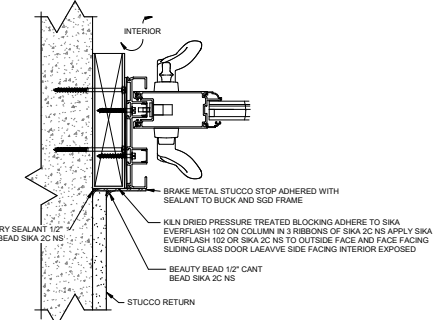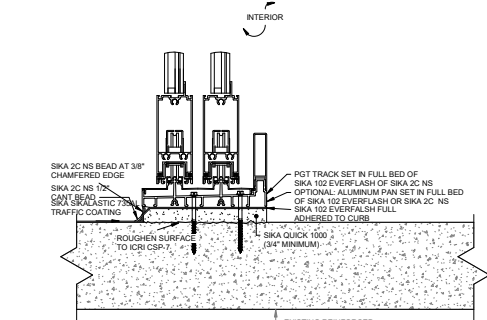

1. REMOVE AND DISPOSE EXISTING SLIDING GLASS DOOR, FRAME, AND BUCKING. REPAIR CONCRETE IF NECESSARY-FULL BED OF EVERFLASH 102 OR SIKACANT NS.
2. REMOVE ALL DUST AND DEBRIS FROM SUBSTRATE. CUT BACK STUCCO AT JAMBS AND HEADER MINIMAL AMOUNT TO ACCOUNT FOR NEW FRAME WIDTH AND INSTALLATION OF PRIMARY SEALANT. CONFIRM LOCATION WITH SLIDING GLASS DOOR INSTALLER. ONLY DEPTH INTO STRUCTURAL SLAB BENEATH GROUT BED.
3. VERIFY SUBSTRATE IS 4% OR LESS MOISTURE CONTENT. APPLY SIKACANT EVERFLASH 102 TO COLUMNS AND CEILING CONSTRAINING INTERIOR TO INSIDE LOCATH OF BUCK PLACEMENT.
4. ALLOW EVERFLASH 2 HOURS TO CURE. APPLY 3 RIBBONS OF SIKACANT NS COMPLETELY TO FACE OF BUCK ATTACHING TO SUBSTRATE. BUCK TO BE SET FLUSH WITH OUTSIDE FACE OF SLIDING GLASS DOOR FRAME. INSTALL PRIMARY SEALANT. BUCK MAY NEED TO BE RIPPED DOWN IN WIDTH TO MATCH FRAME WIDTH. SEE BUCK REQUIREMENTS AND INSTALLATION UNDER GENERAL NOTES 2-4 OF SIKS-01.
5. APPLY SIKACANT EVERFLASH OR SIKACANT NS COMPLETELY TO OUTSIDE FACE AND SIDE FACING SLIDING GLASS DOOR FRAME. IF CAVITY EXISTS BETWEEN BOTTOM OF BUCK AND SILL PAN, INJECT EVERFLASH TO CAVITY FULLY. ALLOW EVERFLASH TO CURE 2 HOURS.
6. INSTALL SLIDING GLASS DOOR FRAME PER MANUFACTURER'S GUIDELINES. FOLLOW GENERAL NOTE 6 REGARDING FASTENER INSTALLATIONS.
7. ATTACH BREAK METAL STUCCO STOPS AT JAMBS AND HEADER TO EXISTING SLIDING GLASS DOOR FRAME. ALL BREAK METAL STUCCO STOPS TO HAVE FACTORY APPLIED FINISH TO MATCH DOOR FRAME.
8. REPLACE REMOVED STUCCO.
9. APPLY BEAUTY BEAD BETWEEN STUCCO AND STUCCO STOP.

1 DOOR SILL, HEAD & JAMB WATERPROOFING
1/4" = 1'-0"

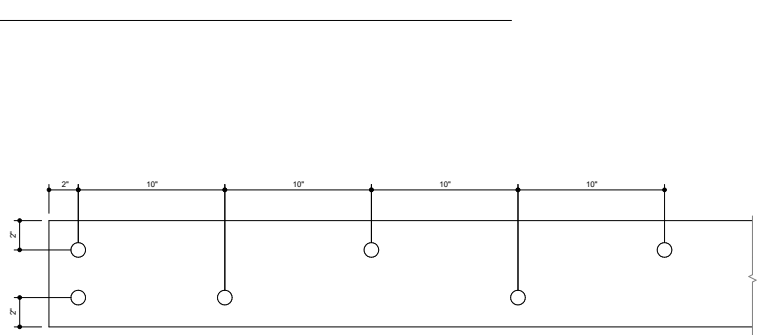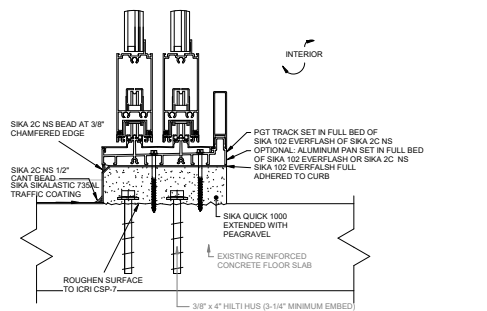

2 BUCK FASTENING SCHEDULE
3/4" = 1'-0"

3 REINFORCED DOOR CURB
1/4" = 1'-0"

SCALE: License #9020
Expiry: 02/2025

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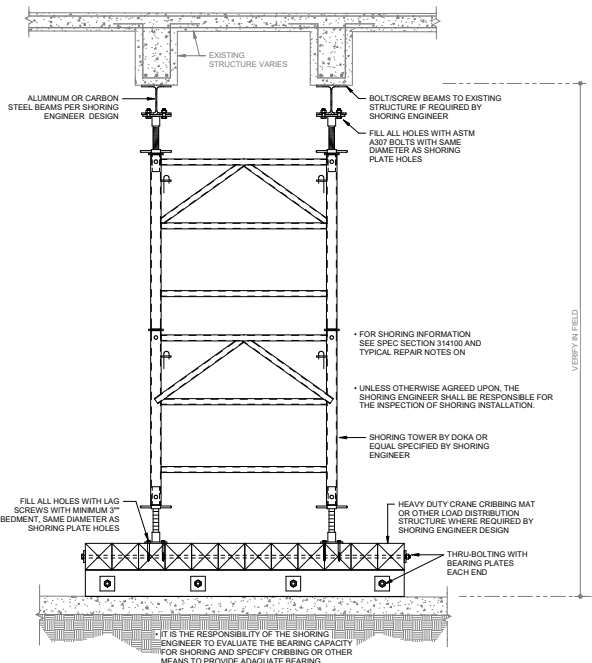
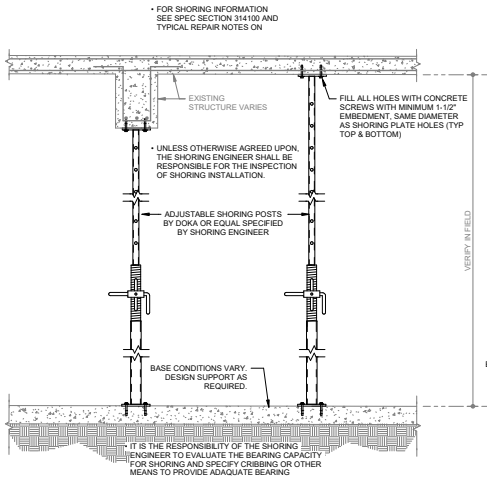
No.	Date	Revisions

DESIGNED HR/JB/IRM	DRAWN HR/JB/IRM
CHECKED RM	APPROVED FPM

Project No.: 18217
Date: 04/26/21
Scale: As indicated
Sheet Title:
BALCONY DOOR
WATERPROOFING

Sheet No.:
S2C-3.3

THESE DETAILS ARE CONCEPTUAL ONLY. IT IS THE SOLE RESPONSIBILITY OF THE DELEGATED SHORING ENGINEER TO VERIFY CAPACITIES OF BEAMS, SLABS, ETC IN ORDER TO DETERMINE SHORING SYSTEM TYPE / CONFIGURATION AND SPACING.



1 SHORING REQUIREMENTS FOR CONCRETE REPAIRS
3/4" = 1'-0"

CHAMPLAIN TOWERS SOUTH CONDOMINIUM
8777 COLLINS AVENUE
SURFSIDE, FLORIDA 33154

CHAMPLAIN TOWERS SOUTH 40-YEAR BUILDING
REPAIR & RESTORATION
PHASE IIC: OVERALL BUILDING
REPAIR AND RESTORATION

SCALE License 96025
Expires 03/29/23

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No.	Date	Revisions

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CHECKED: RM | APPROVED: FPM


Project No.: 18217

Date: 04/26/21

Scale: 3/4" = 1'-0"

Sheet Title:
SHORING DETAILS

Sheet No.:
S2C-3.4

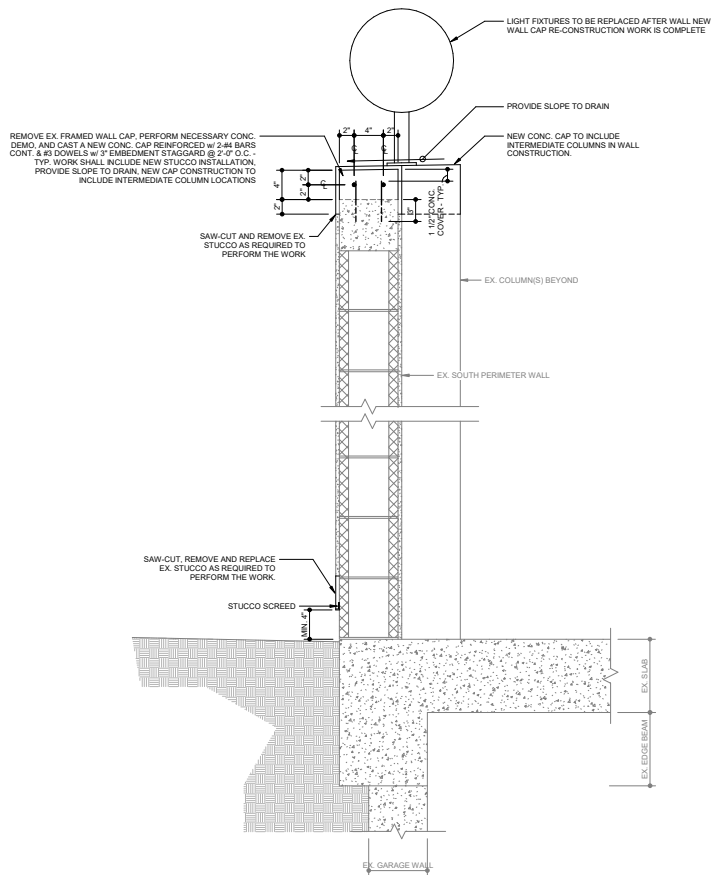

1 SOUTH PERIMETER WALL REPAIR
1 1/2" = 1'-0"

CHAMPLAIN TOWERS SOUTH CONDOMINIUM
8777 COLLINS AVENUE
SURFSIDE, FLORIDA 33164

CHAMPLAIN TOWERS SOUTH 40-YEAR BUILDING REPAIR & RESTORATION
PHASE IIC: OVERALL BUILDING REPAIR AND RESTORATION

SEAL License #6025
Expires 03/2023

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No.	Date	Revisions

DESIGNED HR/JB/IR	DRAWN HR/JB/IR
CHECKED RM	APPROVED FPM

Project No.: 18217
Date: 04/26/21
Scale: 1 1/2" = 1'-0"
Sheet Title:
SOUTH WALL REPAIR

Sheet No.:
S2C-3.6